



U.S. Army Corps  
of Engineers  
Baltimore District

# Public Notice

In Reply to Application Number  
NABOP-RM (PG DPWT/HANOVER PARKWAY/SWM  
POND RETROFIT) 2017-62117

PN 18-28

Comment Period: May 21, 2018 to June 21, 2018

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**THE PURPOSE OF THIS PUBLIC NOTICE IS TO SOLICIT COMMENTS FROM THE PUBLIC REGARDING THE WORK DESCRIBED BELOW. NO DECISION HAS BEEN MADE AS TO WHETHER OR NOT A PERMIT WILL BE ISSUED AT THIS TIME.**

This District has received an application for a Department of the Army permit pursuant to **Section 404 of the Clean Water Act (33. U.S.C. 1344)** as described below:

**APPLICANT:** Mr. Michael Gidey  
Prince Georges County Department of the Environment  
1801 McCormick Drive, Suite 500  
Largo, Maryland 20774

**WATERWAY AND LOCATION OF THE PROPOSED WORK:** The project is located within an instream stormwater management pond in an unnamed tributary of Brier Ditch and Greenbelt Park Branch located southeast of the intersection of Ora Glen Drive and Hanover Parkway in Greenbelt, Prince George's County, Maryland.

**PROPOSED WORK AND PURPOSE:** The applicant proposes to retrofit an existing regional stormwater management pond by creating 3 forebays with a total of approximately 5,900 square feet of inflow and outflow riprap flow protection and excavating and grading bottom contours to create a deeper wet pond stormwater management facility, permanently impacting approximately 195,662 square feet of non-tidal open water. All the existing open water would be excavated during bulldozing for the proposed work and there would be no increase in pond size.

The project is proposed to improve water quality by reducing sediment, total nitrogen, and phosphorus loading to downstream waters and the Chesapeake Bay in order to comply with the Total Maximum Daily Load requirements set for Prince George's County in their MS4 permit.

The applicant has avoided and minimized impacts to aquatic resources to the maximum extent. No other pond location would allow for water quality improvements to this watershed. The pond must be deepened to increase the capacity of the facility and treat stormwater to improve water quality.

The applicant considers that the project is an environmental enhancement, therefore, no compensatory mitigation is proposed.

All work will be completed in accordance with the enclosed plan(s). If you have any questions concerning this matter, please contact Mr. Steven Harman, Project Manager, at 410-962-6082 or [steve.harman@usace.army.mil](mailto:steve.harman@usace.army.mil).

The decision whether to issue a permit will be based on an evaluation of the probable impacts, including cumulative impacts of the proposed activity on the public interest. That decision will reflect the national concern for both protection and utilization of important resources. The benefit, which reasonable may be expected to accrue from the proposal, must be balanced against its reasonably foreseeable detriments. All factors, which may be relevant to the proposal will be considered, including the cumulative effects thereof; among those are conservation, economic, aesthetics, general environmental concerns, wetlands, cultural values, fish and wildlife values, flood hazards, flood plain values, land use, navigation, shoreline erosion and accretion, recreation, water supply and conservation, water quality, energy needs, safety, food and fiber production, mineral needs, and consideration of property ownership and in general, the needs and welfare of the people.

The Corps of Engineers is soliciting comments from the public; Federal, State, and local agencies and officials; Indian Tribes; and other interested parties in order to consider and evaluate the impacts of this proposed activity. Any comments received will be considered by the Corps of Engineers to determine whether to issue, modify, condition or deny a permit for this proposal. To make this decision, comments are used to assess impacts on endangered species, historic properties, water quality, general environmental effects, and the other public interest factors listed above. Comments are used in the preparation of an Environmental Assessment and/or an Environmental Impact Statement pursuant to the National Environmental Policy Act. Comments provided will become part of the public record for this action. Comments are also used to determine the need for a public hearing and to determine the overall public interest of the proposed activity. Written comments concerning the work described above related to the factors listed above or other pertinent factors must be received by the District Engineer, U.S. Army Corps of Engineers, Baltimore District, Attn.: Mr. Steven Harman, CENAB-OPR-M, 2 Hopkins Plaza, Baltimore, Maryland 21201 within the comment period specified above.

**ESSENTIAL FISH HABITAT:** The Magnuson-Stevens Fishery Conservation and Management Act (MSFCMA), as amended by the Sustainable Fisheries Act of 1996 (Public Law 04-267), requires all Federal agencies to consult with the National Marine Fisheries Service (NMFS) on all actions, or proposed actions, permitted, funded, or undertaken by the agency that may adversely effect Essential Fish Habitat (EFH). The project site does lie in or adjacent to EFH as described under MSFCMA.

**WATER QUALITY CERTIFICATION:** The applicant is required to obtain a water quality certification in accordance with Section 401 of the Clean Water Act from the Maryland Department of the Environment. Any written comments concerning the work described above which relate to water quality certification must be received by the Wetlands and Waterways Program, Maryland Department of the Environment, Montgomery Park Business Center, 1800 Washington Boulevard, Suite 430, Baltimore, Maryland 21230-1708 within the comment period as specified above to receive consideration. The Section 401 certifying agency has a statutory limit of one year from the date of this public notice to make its decision.

**COASTAL ZONE MANAGEMENT PROGRAMS:** Where applicable, the applicant has certified in this application that the proposed activity complies with and will be conducted in a manner

consistent with the approved Coastal Zone Management (CZM) Program. By this public notice, we are requesting the State concurrence or objection to the applicant's consistency statement. It should be noted that the CZM Program has a statutory limit of 6 months to make its consistency determination.

The applicant must obtain any State or local government permits which may be required.

A preliminary review of this application indicates that the proposed work will not affect Federal listed threatened or endangered species or their critical habitat, pursuant to Section 7 of the Endangered Species Act, as amended. As the evaluation of this application continues, additional information may become available which could modify this preliminary determination.

Review of the latest published version of the National Register of Historic Places indicates that no registered properties listed as eligible for inclusion, therein, are located at the site of the proposed work. Currently unknown archeological, scientific, prehistoric, or historical data may be lost or destroyed by the work to be accomplished under the request permit.


The evaluation of the impact of this project on the public interest will include application of the guidelines promulgated by the Administrator, U.S. Environmental Protection Agency, under authority of Section 404 of the Clean Water Act.

Any person who has an interest which may be adversely affected by the issuance of this permit may request a public hearing. The request, which must be in writing, must be received by the District Engineer, U.S. Army Corps of Engineers, Baltimore District, Mr. Steven Harman, Project Manager, Maryland Section Southern, 2 Hopkins Plaza, Baltimore, Maryland 21201, within the comment period as specified above to receive consideration. Also it must clearly set forth the interest which may be adversely affected by this activity and the manner in which the interest may be adversely affected.

It is requested that you communicate this information concerning the proposed work to any persons known by you to be interested and not being known to this office, who did not receive a copy of this notice.

FOR THE DISTRICT ENGINEER:

Kathy B. Anderson  
Chief, Maryland Section Southern

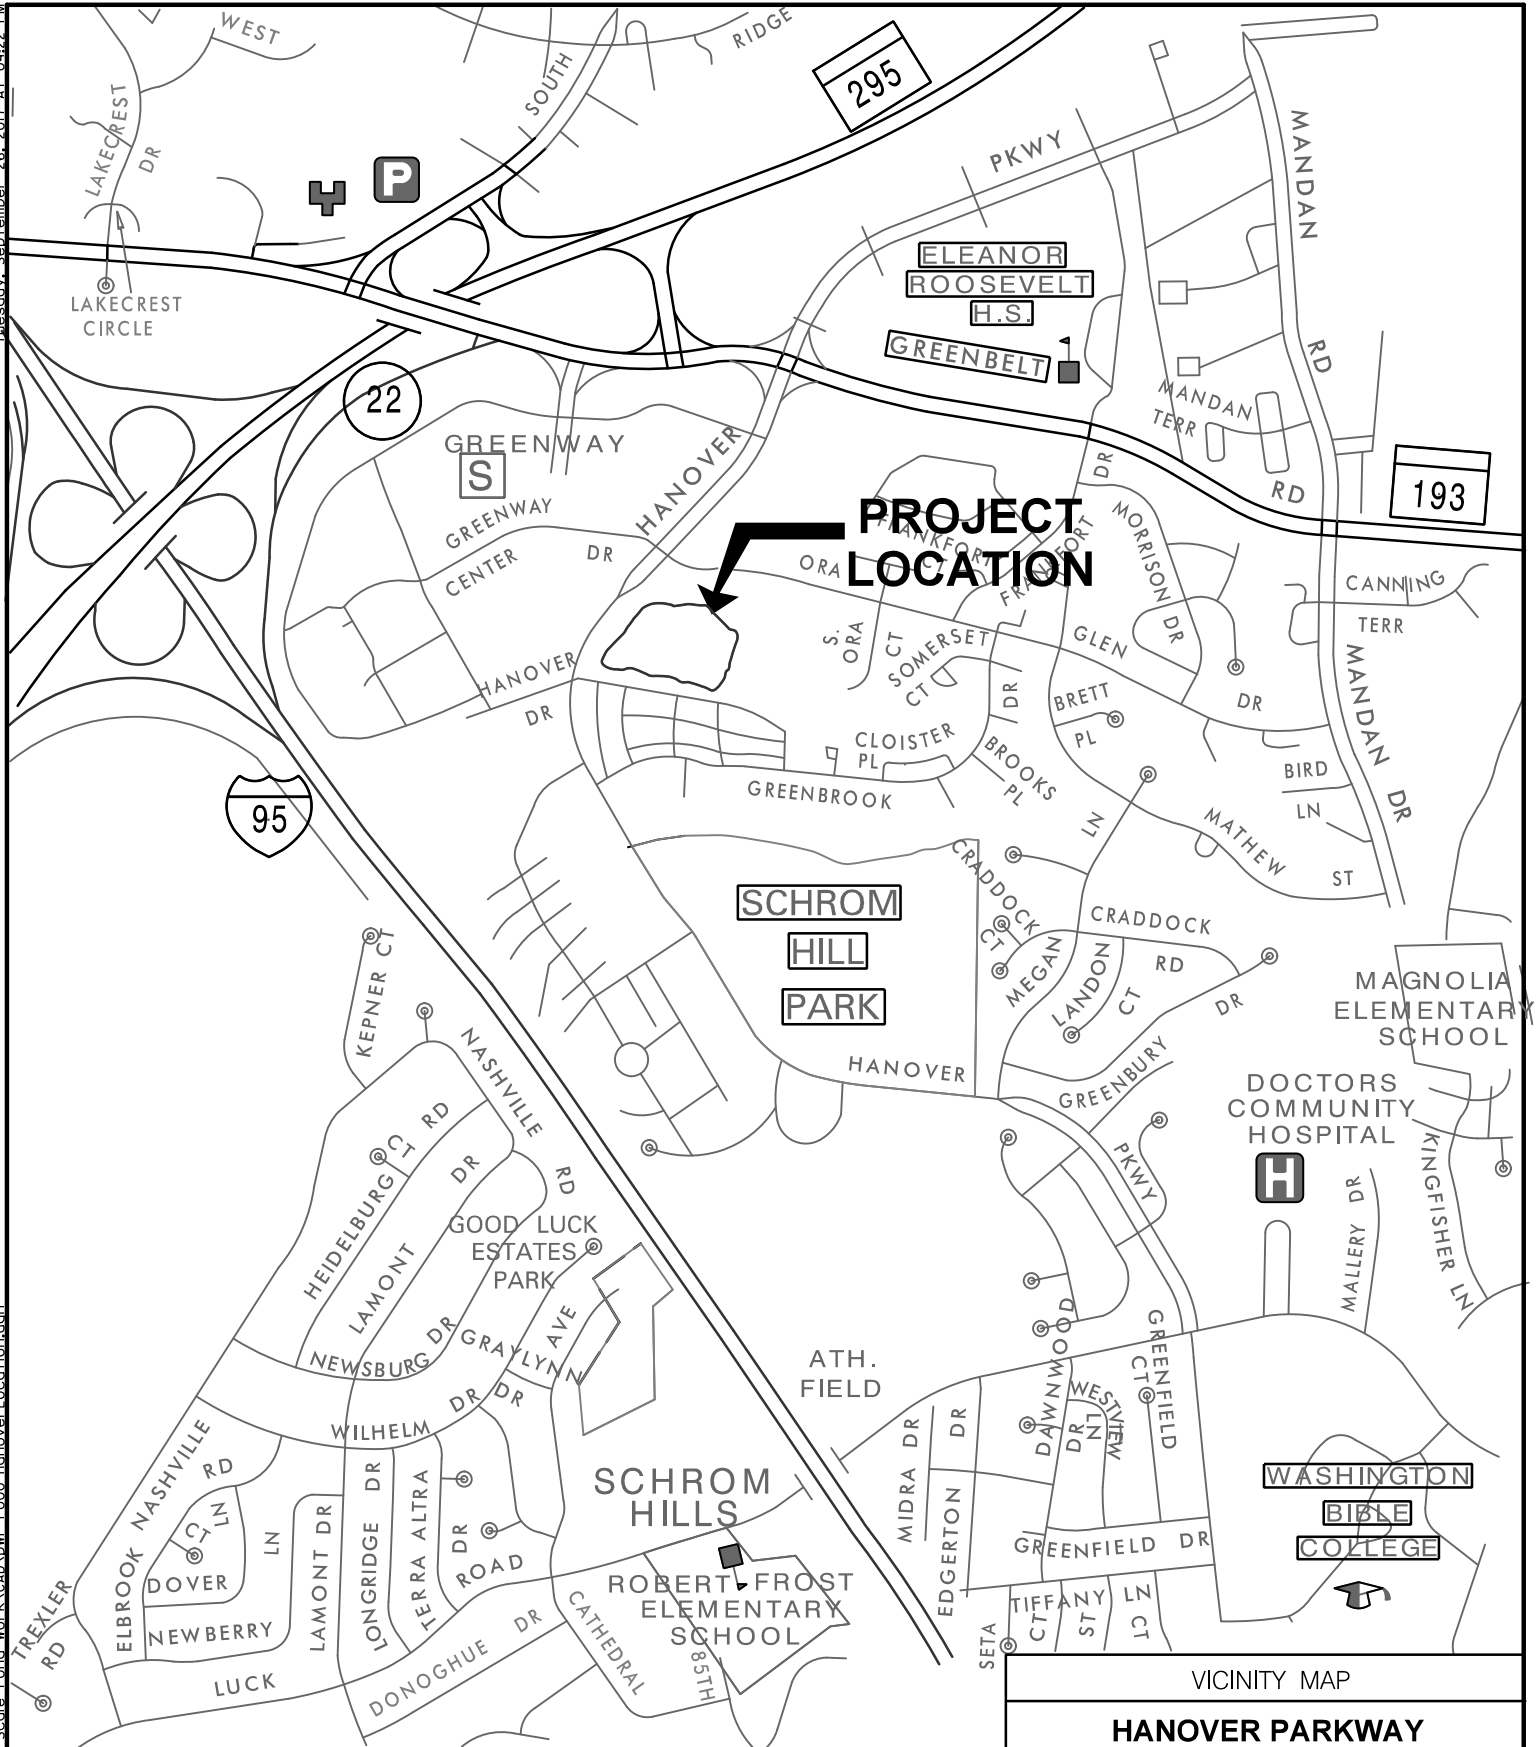

NOT TO SCALE

AGENT:



PURPOSE: JOINT PERMIT APPLICATION

APPLICATION BY:

PRINCE GEORGE'S COUNTY  
DEPARTMENT OF THE  
ENVIRONMENT


VICINITY MAP

**HANOVER PARKWAY  
STORMWATER MANAGEMENT  
FACILITY RETROFIT**

CONTRACT NO:	S10-073
COUNTY:	PRINCE GEORGE'S
STATE:	MARYLAND
DATE:	SEPTEMBER 29, 2017

SHEET 1 OF 3

FILE NAME: C:\Projects\WV\Prince Georges County\NPDES Contract\Task Order 12\Small Scale Pond Work\8000\Work\03\Final Plans (100% Submittal)\910\_CAD\20-SHEETS\C200\_Grading\_Drainage\Site Layout\NAME Layout11\_PLOTTED\_Monday, January 29, 2018 - 10:04am USER: hain.park

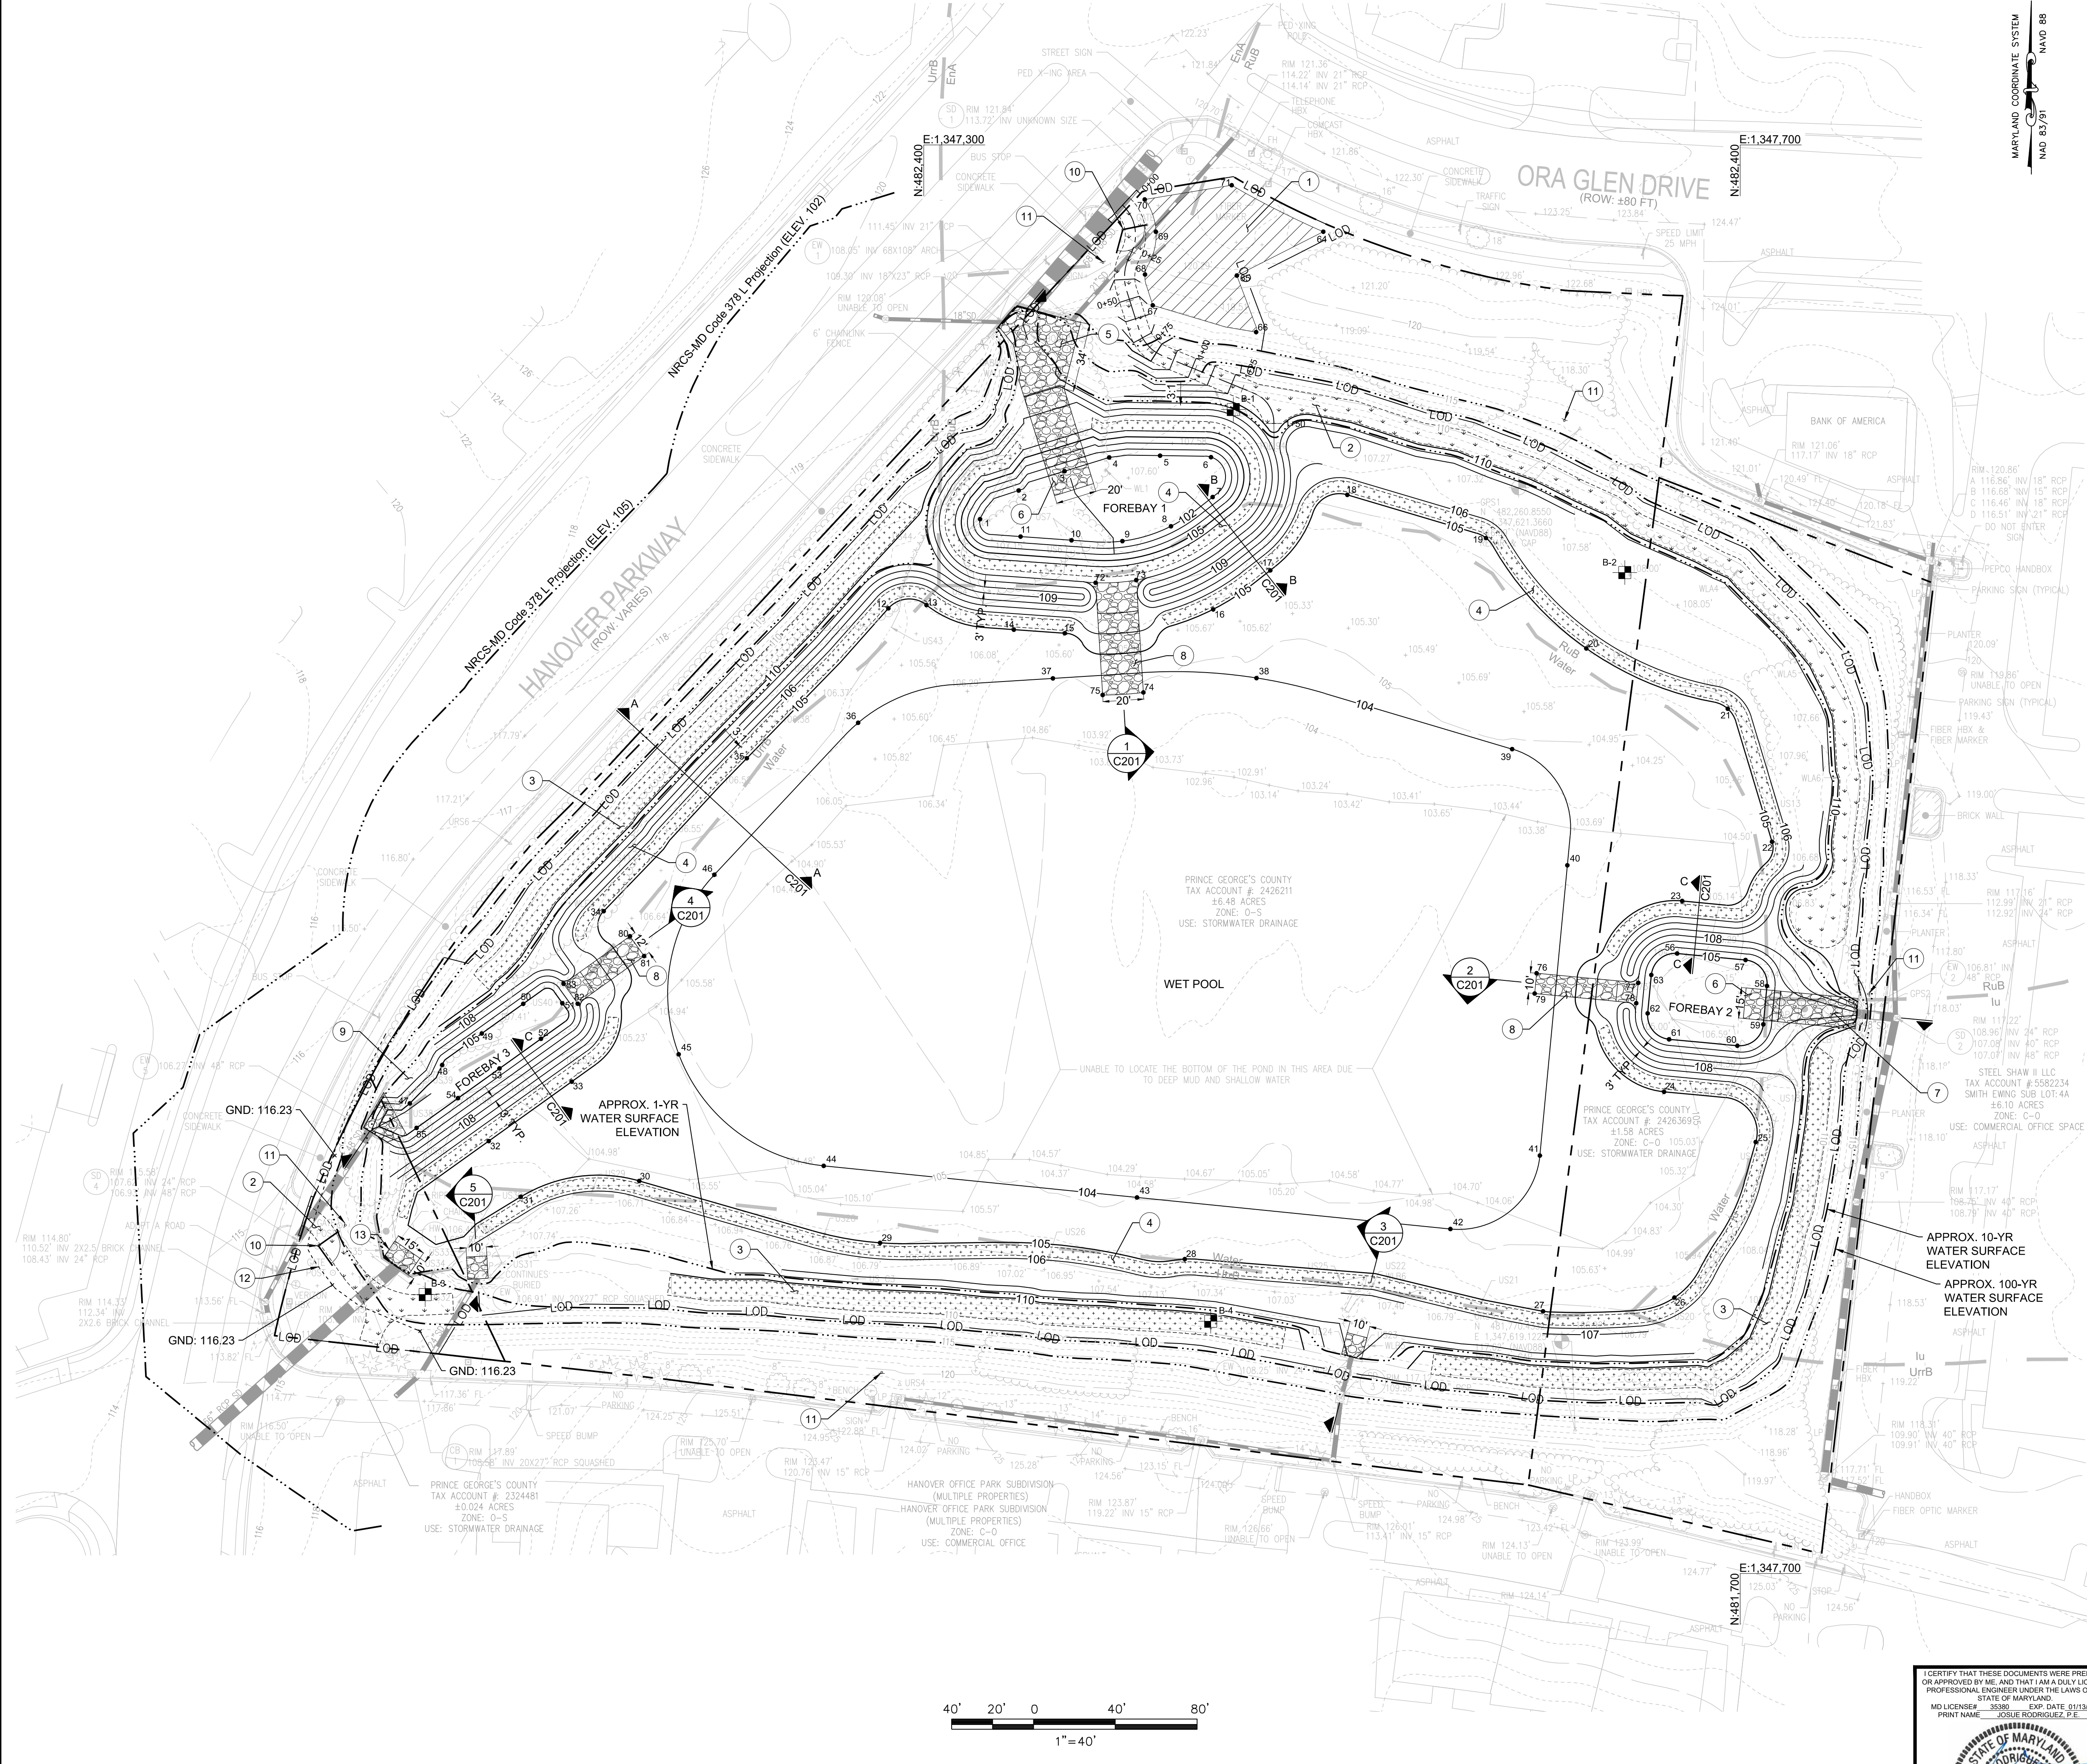

**LEGEND**

- SITE PROPERTY BOUNDARY
- LIMITS OF DISTURBANCE
- LIMITS OF FIELD SURVEY
- - - EX. MAJOR CONTOUR
- - - EX. MINOR CONTOUR
- EX. STORM DRAIN PIPE
- EX. VEGETATION EDGE
- EX. WATER EDGE
- - - EX. FENCE
- SOIL BOUNDARY
- - - PROPOSED CONTOUR
- MD CODE 378 "L" PROJECTION
- SOIL BORING LOCATION
- LAYOUT POINT
- RIPRAP PROTECTION
- TURF GRASS ACCESS ROAD
- SAFETY BENCH
- STAGING/STOCKPILE AREA

**NOTES:**

- SEE SHEET G002 FOR CONSTRUCTION LAYOUT POINT DATA.
- SEE SHEET C201 FOR WATER SURFACE ELEVATIONS.
- EXCESS STOCKPILE MATERIAL SHALL BE HAULED AWAY TO A SITE THAT HAS AN ACTIVE AND APPROVED SEDIMENT CONTROL PLAN.

- KEYNOTES:**
- ±3,600 SF STAGING/STOCKPILE AREA.
  - TURF GRASS 10' ACCESS ROAD WITH TURNAROUND.
  - 10' SAFETY BENCH. SEE SHEET C201 FOR TYPICAL SECTION.
  - 5' SAFETY BENCH. SEE SHEET C201 FOR TYPICAL SECTION.
  - ±1,110 SF ROCK OUTLET PROTECTION. WIDTH OF RIPRAP TO EXTEND FROM GABION WALL TO END OF CONCRETE HEADWALL. SEE PROFILE FOR TRANSITION TO RIPRAP INFLOW PROTECTION.
  - RIPRAP INFLOW PROTECTION. SEE PROFILE.
  - ROCK OUTLET PROTECTION. SEE PROFILE FOR TRANSITION TO RIPRAP INFLOW PROTECTION.
  - OVERFLOW SPILLWAY WITH RIPRAP INFLOW PROTECTION. SEE PROFILE. CREST ELEV.: 107.00.
  - ±250 SF RIPRAP INFLOW PROTECTION. WIDTH OF RIPRAP TO EXTEND TO END OF HEADWALL. SEE PROFILE.
  - ACCESS GATE. SEE DETAIL 3 ON SHEET C202.
  - POND WARNING SIGN. SEE DETAIL 4 ON SHEET C202. LOCATION TO BE FIELD VERIFIED AND APPROVED BY THE ENGINEER OF RECORD.
  - RAISED BERM GRADED TO SURROUNDING FINISH GRADE. BERM ELEV.: 116.23 (116 CONTOUR NOT SHOWN FOR CLARITY).
  - ±150 SF RIPRAP APRON. 19" MIN. THICKNESS OF MDE CLASS I ON NON-WOVEN GEOTEXTILE. D<sub>50</sub>: 9.5" D<sub>100</sub>: 15"



DEPARTMENT OF THE ENVIRONMENT (DoE)  
 PRINCE GEORGE'S COUNTY, MARYLAND  
**PEER REVIEW APPROVAL STAMP**

"I hereby certify that I have successfully completed participation in DPPE's Peer Review Program. I have reviewed these plans in Detail and they are in conformance with the County's Code, General Specifications and Standards."

APPROVAL DATE: \_\_\_\_\_  
 PEER REVIEWER'S NAME: BENJAMIN MOSIER, P.E.  
 PEER REVIEWER'S SIGNATURE: \_\_\_\_\_  
 COMPANY NAME: SOLTESZ  
 LICENSE NUMBER: 40806  
 PERMIT NUMBER: 29650-2017-0

DEPARTMENT OF THE ENVIRONMENT  
 STORMWATER MANAGEMENT DIVISION  
 PRINCE GEORGE'S COUNTY, MARYLAND

FINAL (100% SUBMITTAL)

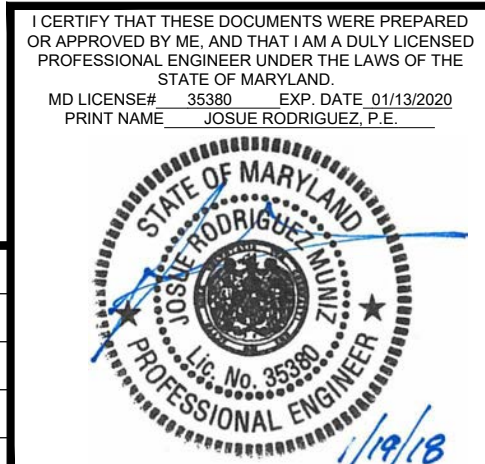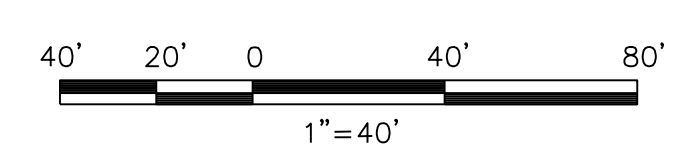

PREPARED BY:  
**URS**  
 12420 MILESTONE CENTER DR., SUITE 150  
 GERMANTOWN, MD 20876

DESIGNED: BJP DRAWN: BJP CHECKED BY: JRM  
 SCALE: AS SHOWN DATE: JAN. 19, 2018  
 PROJECT NO. 60530854  
 SHEET NO. C200 (SD 6 OF 14) (SC 6 OF 14)

DEPARTMENT OF THE ENVIRONMENT

CAPITAL PROJECTS SECTION  
 STORMWATER MANAGEMENT DIVISION

HANOVER PARKWAY  
 STORMWATER MANAGEMENT FACILITY RETROFIT  
 21st Election District  
 PRINCE GEORGE'S COUNTY MARYLAND

GRADING AND DRAINAGE PLAN

DATE:	REVISIONS

ASSOCIATE DIRECTOR	DATE
SCALE: -	DWG. -
APPROVED	SECTION HEAD
DESIGNED:	DATE
DRAWN:	C.L.P.
CHECKED BY:	
PROJECT MANAGER	CONTRACT NO.