

U.S. Army Corps of Engineers
Baltimore District

Public Notice

In Reply to Application Number CENAB-OP-RMN (The Howard Research & Development Corp./ Columbia Crescent/Infrastructure) 2014-61063-M36

PN 14-69

Comment Period: December 15, 2014 to January 15, 2015

THE PURPOSE OF THIS PUBLIC NOTICE IS TO SOLICIT COMMENTS FROM THE PUBLIC REGARDING THE WORK DESCRIBED BELOW. NO DECISION HAS BEEN MADE AS TO WHETHER OR NOT A PERMIT WILL BE ISSUED AT THIS TIME.

This District has received an application for a Department of the Army permit pursuant to Section 404 of the Clean Water Act (33. U.S.C. 1344) as described below:

APPLICANT: Mr. Robert Jenkins

The Howard Research & Development Corporation

10221 Wincopin Circle, Suite 300

Columbia, Maryland 21044

WATERWAY AND LOCATION:

Unnamed tributaries to the Little Patuxent River, and adjacent non-tidal wetlands, adjacent to Merriweather Post Pavilion, in Columbia's New Town District, Columbia, Howard County, Maryland

PROPOSED WORK AND PURPOSE:

The proposed project is the construction of a multi-phased, mixed-use development, including residences, office buildings, commercial space, a hotel and conference center, cultural and recreational facilities, a fire station, associated roadways, utilities, and infrastructure, and wetland and stream mitigation. Impacts to jurisdictional waters of the U.S., including wetlands, will occur due to discharges of fill for construction of roadways, including two bottomless arch culverts and a bridge, two pedestrian boardwalks, 8-inch sanitary sewer and 16-inch potable water lines, stormwater outfalls, and wetland and stream mitigation. Where possible, project construction impacts were located in areas where stream mitigation will occur to minimize overall project impacts.

The proposed project will have permanent impacts to 18,117 square feet and temporary impacts to 3,685 square feet of non-tidal wetlands; these totals include 16,198 square feet of permanent impacts and 3,685 square feet of temporary impacts to forested wetlands and 1,979 square feet of permanent impacts to emergent wetlands. The project will also permanently impact 975 linear feet (1,397 square feet) and temporarily impact 130 linear feet (130 square feet) of non-tidal stream channel. The project's proposed mitigation will temporarily impact 19,158 square feet of non-tidal wetlands and permanently impact 1,828 linear feet (13,057 square feet) of non-tidal stream channel. On-site project mitigation will provide for the creation of 37,762 square feet of forested wetlands and 2,004 square feet of emergent wetlands, the enhancement of 14,091 square feet of forested wetlands, and the restoration of 1,828 linear feet (13,057 square feet) of stream channel. Although not part of the required mitigation to offset project impacts, the applicant proposes to create an additional 20,608 square feet of forested wetlands and

20,290 square feet of emergent wetlands. Project impacts have been avoided and minimized through the use of two bottomless arch culverts, a bridge, and locating other project impacts, such as utility line stream crossings, in areas where stream restoration will occur.

All work is to be completed in accordance with the enclosed project and mitigation plans. If you have any questions concerning this matter, please contact Mr. John Policarpo at (410) 962-4522 or at john.n.policarpo@usace.army.mil.

The decision whether to issue a permit will be based on an evaluation of the probable impacts, including cumulative impacts of the proposed activity on the public interest. That decision will reflect the national concern for both protection and utilization of important resources. The benefit, which reasonable may be expected to accrue from the proposal, must be balanced against its reasonably foreseeable detriments. All factors, which may be relevant to the proposal will be considered, including the cumulative effects thereof; among those are conservation, economic, aesthetics, general environmental concerns, wetlands, cultural values, fish and wildlife values, flood hazards, flood plain values, land use, navigation, shoreline erosion and accretion, recreation, water supply and conservation, water quality, energy needs, safety, food and fiber production, mineral needs, and consideration of property ownership and in general, the needs and welfare of the people.

The evaluation of the impact of the work described above on the public interest will include application of the Clean Water Act Section 404(b)(1) Guidelines promulgated by the Administrator, U.S. Environmental Protection Agency, under authority of Section 404 of the Clean Water Act.

The Corps of Engineers is soliciting comments from the public; Federal, State, and local agencies and officials; Indian Tribes; and other interested parties in order to consider and evaluate the impacts of this proposed activity. Any comments received will be considered by the Corps of Engineers to determine whether to issue, modify, condition, or deny a permit for this proposal. To make this decision, comments are used to assess impacts on endangered species, historic properties, water quality, general environmental effects, and the other public interest factors listed above. Comments are used in the preparation of an Environmental Assessment and/or an Environmental Impact Statement pursuant to the National Environmental Policy Act. Comments provided will become part of the public record for this action. Comments are also used to determine the need for a public hearing and to determine the overall public interest of the proposed activity.

Written comments concerning the work described above related to the factors listed above or other pertinent factors must be received by the District Engineer, U.S. Army Corps of Engineers, Baltimore District, ATTN: Mr. John Policarpo, CENAB-OP-RMN, P.O. Box 1715, Baltimore, Maryland 21203-1715, within the comment period specified above.

WATER QUALITY CERTIFICATION: The applicant is required to obtain a water quality certification in accordance with Section 401 of the Clean Water Act from the Maryland Department of the Environment. Any written comments concerning the work described above which relate to water quality certification must be received by the Wetlands and Waterways Program, Maryland Department of the Environment, Montgomery Park Business Center, 1800 Washington Boulevard, Suite 430, Baltimore, Maryland 21230-

1708 within the comment period as specified above to receive consideration. The Section 401 certifying agency has a statutory limit of one year from the date of this public notice to make its decision.

The applicant must obtain any State or local government permits which may be required.

A preliminary review of this application indicates that the proposed work will not affect Federally listed threatened or endangered species or their critical habitat, pursuant to Section 7 of the Endangered Species Act, as amended. As the evaluation of this application continues, additional information may become available which could modify this preliminary determination.

Review of the latest published version of the National Register of Historic Places indicates that no registered properties listed as eligible for inclusion, therein, are located at the site of the proposed work. Currently unknown archeological, scientific, prehistoric, or historical data may be lost or destroyed by the work to be accomplished under the request permit.

Any person who has an interest which may be adversely affected by the issuance of this permit may request a public hearing. The request, which must be in writing, must be received by the District Engineer, U.S. Army Corps of Engineers, Baltimore District, ATTN: Mr. John Policarpo, CENAB-OP-RMN, P.O. Box 1715, Baltimore, Maryland 21203-1715, within the comment period as specified above to receive consideration. Also it must clearly set forth the interest which may be adversely affected by this activity and the manner in which the interest may be adversely affected.


It is requested that you communicate this information concerning the proposed work to any persons know by you to be interested and not being known to this office, who did not receive a copy of this notice.

FOR THE DISTRICT ENGINEER:

Joseph P. DaVia Chief, Maryland Section Northern


DOWNTOWN CRESCENT PHASE I STREAM AND WETLAND MITIGATION

LEGEND

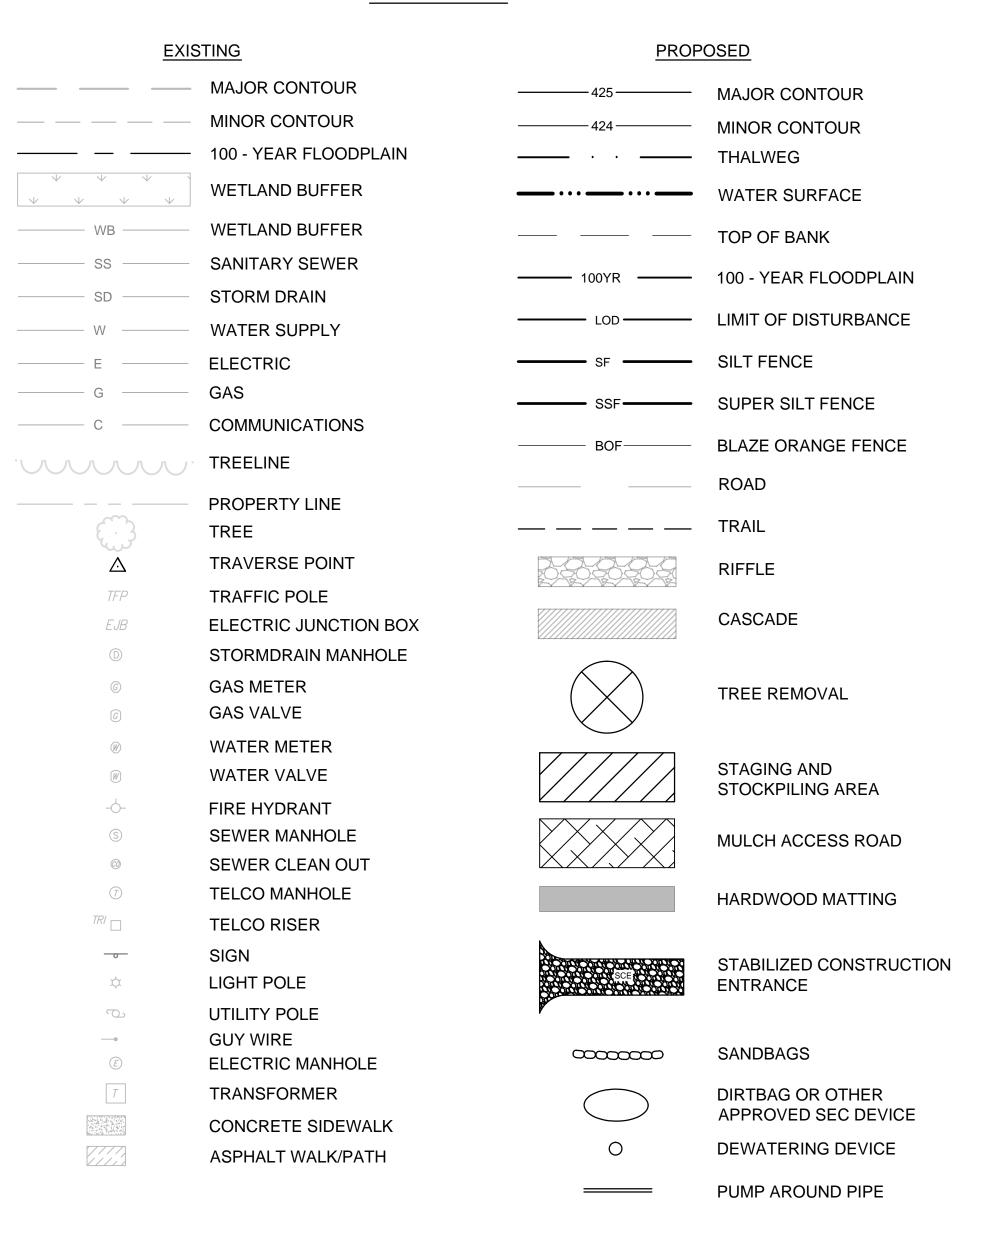

Sheet List Table

| | Officer Liot Table |
|--------------|--|
| Sheet Number | Sheet Title |
| 01 | TITLE SHEET |
| 02 | EXISTING CONDITIONS & GEOMETRY |
| 03 | EXISTING CONDITIONS & GEOMETRY |
| 04 | EXISTING CONDITIONS & GEOMETRY |
| 05 | EXISTING CONDITIONS & GEOMETRY |
| 06 | EXISTING CONDITIONS & GEOMETRY |
| 07 | GRADING & EROSION AND SEDIMENT CONTROL |
| 08 | GRADING & EROSION AND SEDIMENT CONTROL |
| 09 | GRADING & EROSION AND SEDIMENT CONTROL |
| 10 | GRADING & EROSION AND SEDIMENT CONTROL |
| 11 | GRADING & EROSION AND SEDIMENT CONTROL |
| 12 | PROFILE |
| 13 | PROFILE |
| 14 | PROFILE |
| 15 | DETAILS |
| 16 | DETAILS |
| 17 | DETAILS |
| 18 | DETAILS |
| 19 | EROSION AND SEDIMENT CONTROL DETAILS |
| 20 | EROSION AND SEDIMENT CONTROL DETAILS |
| 21 | PLANTING PLAN |
| 22 | PLANTING PLAN |
| 23 | PLANTING PLAN |
| 24 | PLANTING PLAN |
| 25 | PLANTING PLAN |
| 26 | PLANTING DETAILS |
| | |

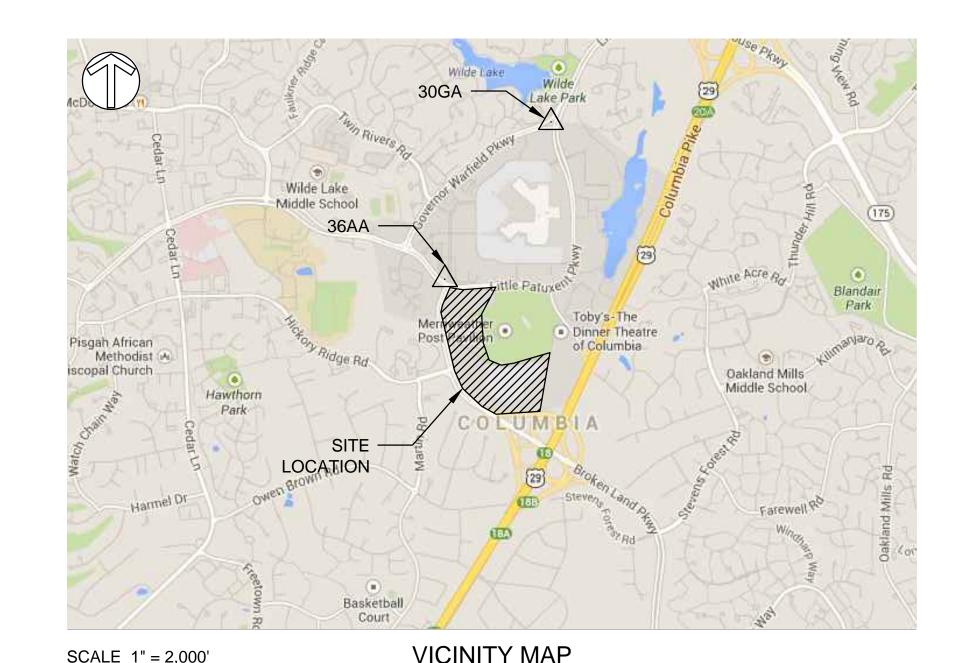

ADC MAP COORD. MAP: 4935 GRID: C7

TOPOGRAPHIC AERIAL SURVEY WAS PERFORMED ON MARCH 2007 BY MCKENZIE SNYDER AND TOPOGRAPHIC FIELD SURVEY ON AUGUST, 2011 BY GUTSHICK, LITTLE AND WEBER.

COORDINATES BASED ON NAD '83 MARYLAND COORDINATE SYSTEM AS PROJECTED BY HOWARD COUNTY GEODETIC CONTROL STATIONS Nos. 36AA, 30GA

THE ELEVATIONS SHOWN HEREON ARE BASED ON NAVD '88 DATUM.

THE EXISTING UTILITIES SHOWN HEREIN WERE DERIVED FROM AVAILABLE PUBLIC RECORDS AND FIELD LOCATIONS BY GUTSHICK, LITTLE AND WEBER, P.A. THE CONTRACTOR MUST DIG TEST PITS BY HAND AT ALL UTILITY CROSSINGS AND CONNECTION POINTS TO VERIFY EXACT LOCATION.

Biohabitats

CLIENT

ISSUES / REVISIONS

COLUMBIA, MD 21044

The Stables Building 2081 Clipper Park Road Baltimore, MD 21211 / ph: 410.554.0156 fx: 410.554.0168 / www.biohabitats.com

Restore the Earth & Inspire Ecological Stewardship

DOWNTOWN CRESCENT PHASE I MITIGATION PLAN

TITLE

ENGINEERS CERTIFICATE
"I CERTIFY THAT THIS PLAN FOR SEDIMENT AND EROSION CONTROL REPRESENTS A PRACTICAL AND WORKABLE PLAN

BASED ON MY PERSONAL KNOWLEDGE OF THE SITE CONDITIONS AND THAT IT WAS PREPARED IN ACCORDANCE WITH THE REQUIREMENTS OF THE HOWARD COUNTY SOIL CONSERVATION DISTRICT"

SIGNATURE OF ENGINEER (PRINTNAME BELOW SIGNATURE)

DATE

DEVELOPERS CERTIFICATE

"I/WE CERTIFY THAT ALL DEVELOPMENT AND CONSTRUCTION WILL BE DONE ACCORDING TO THIS PLAN FOR SEDIMENT AND EROSION CONTROL, AND THAT ALL RESPONSIBLE PERSONNEL INVOLVED IN THE CONSTRUCTION PROJECT WILL HAVE A CERTIFICATE OF ATTENDANCE AT A DEPARTMENT OF THE ENVIRONMENT APPROVED TRAINING PROGRAM FOR THE CONTROL OF SEDIMENT AND EROSION BEFORE THE BEGINNING OF THE PROJECT. I ALSO AUTHORIZE PERIODIC ON-SITE INSPECTION BY THE HOWARD COUNTY SOIL CONSERVATION DISTRICT"

SIGNATURE OF DEVELOPER (PRINTNAME BELOW SIGNATURE)

SHEET


PROJECT NO.: 13020.01 SCALE: AS SHOWN


DWG. NO. :


01 OF 26


Reuse of Documents:


This document and the ideas and designs incorporated herein, as an instrument of Professional Service, is the property of Biohabitats, Inc. and is not to be used in whole or in part, for any other project without the written authorization of Biohabitats, Inc.

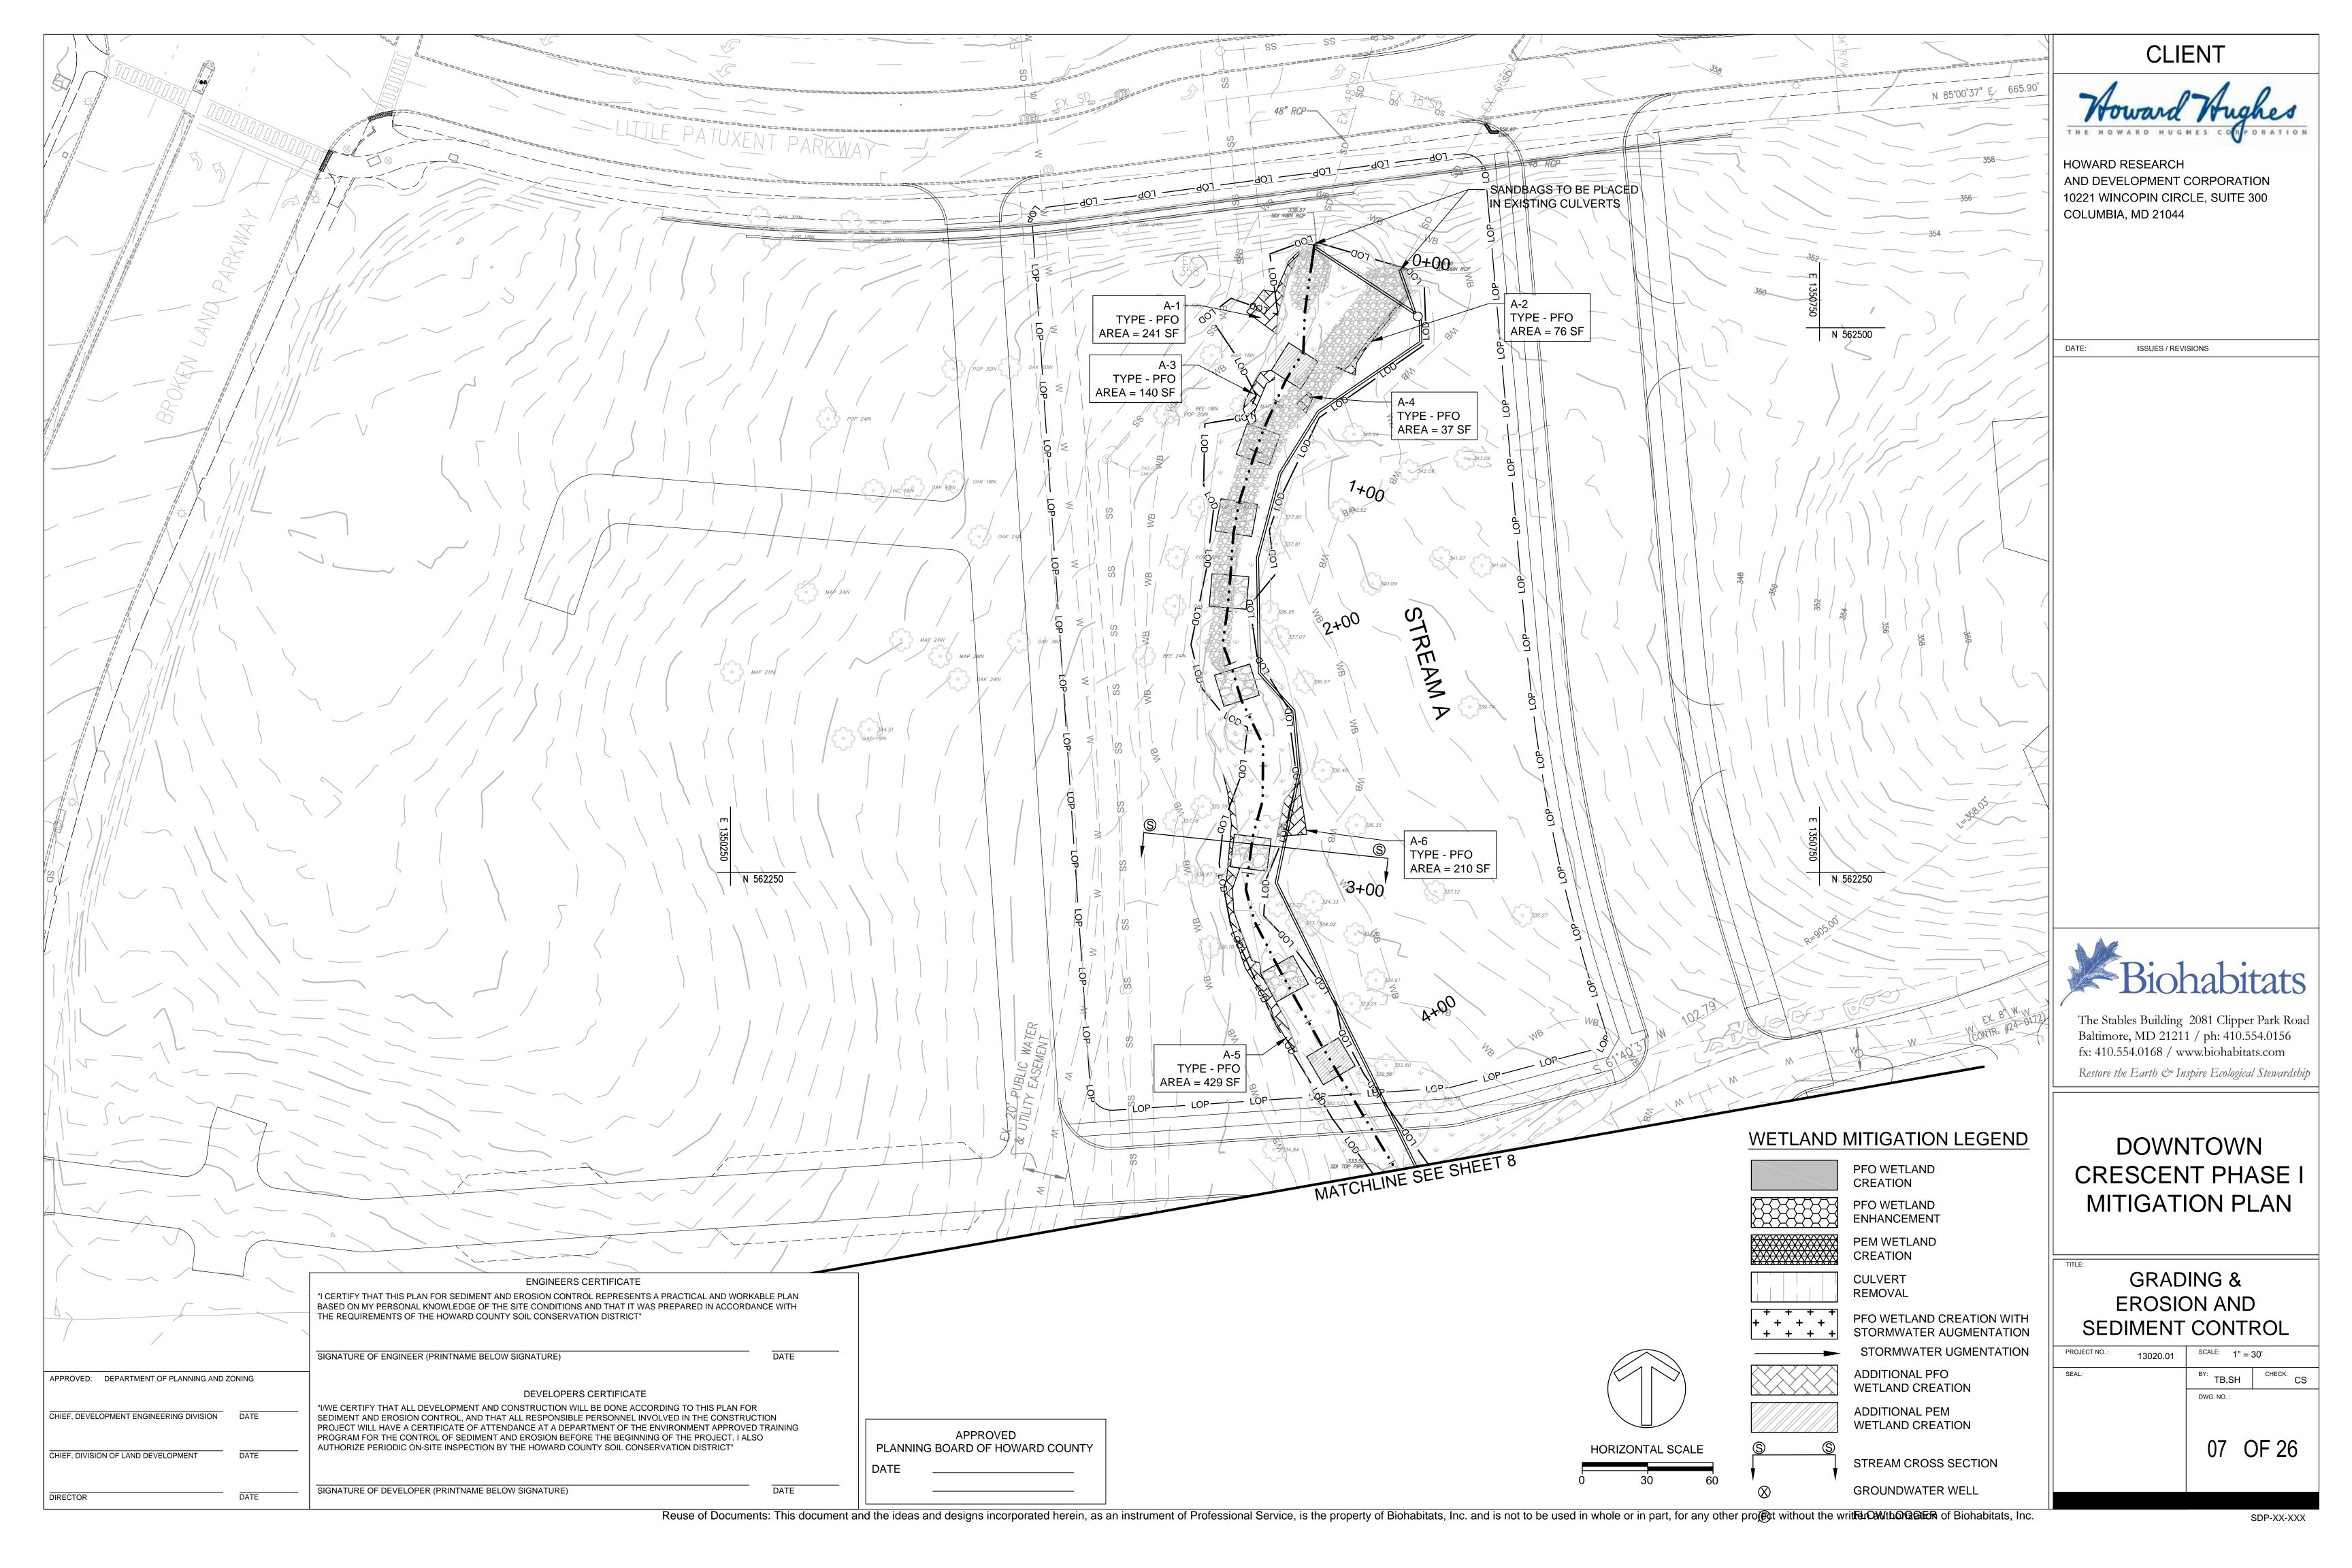


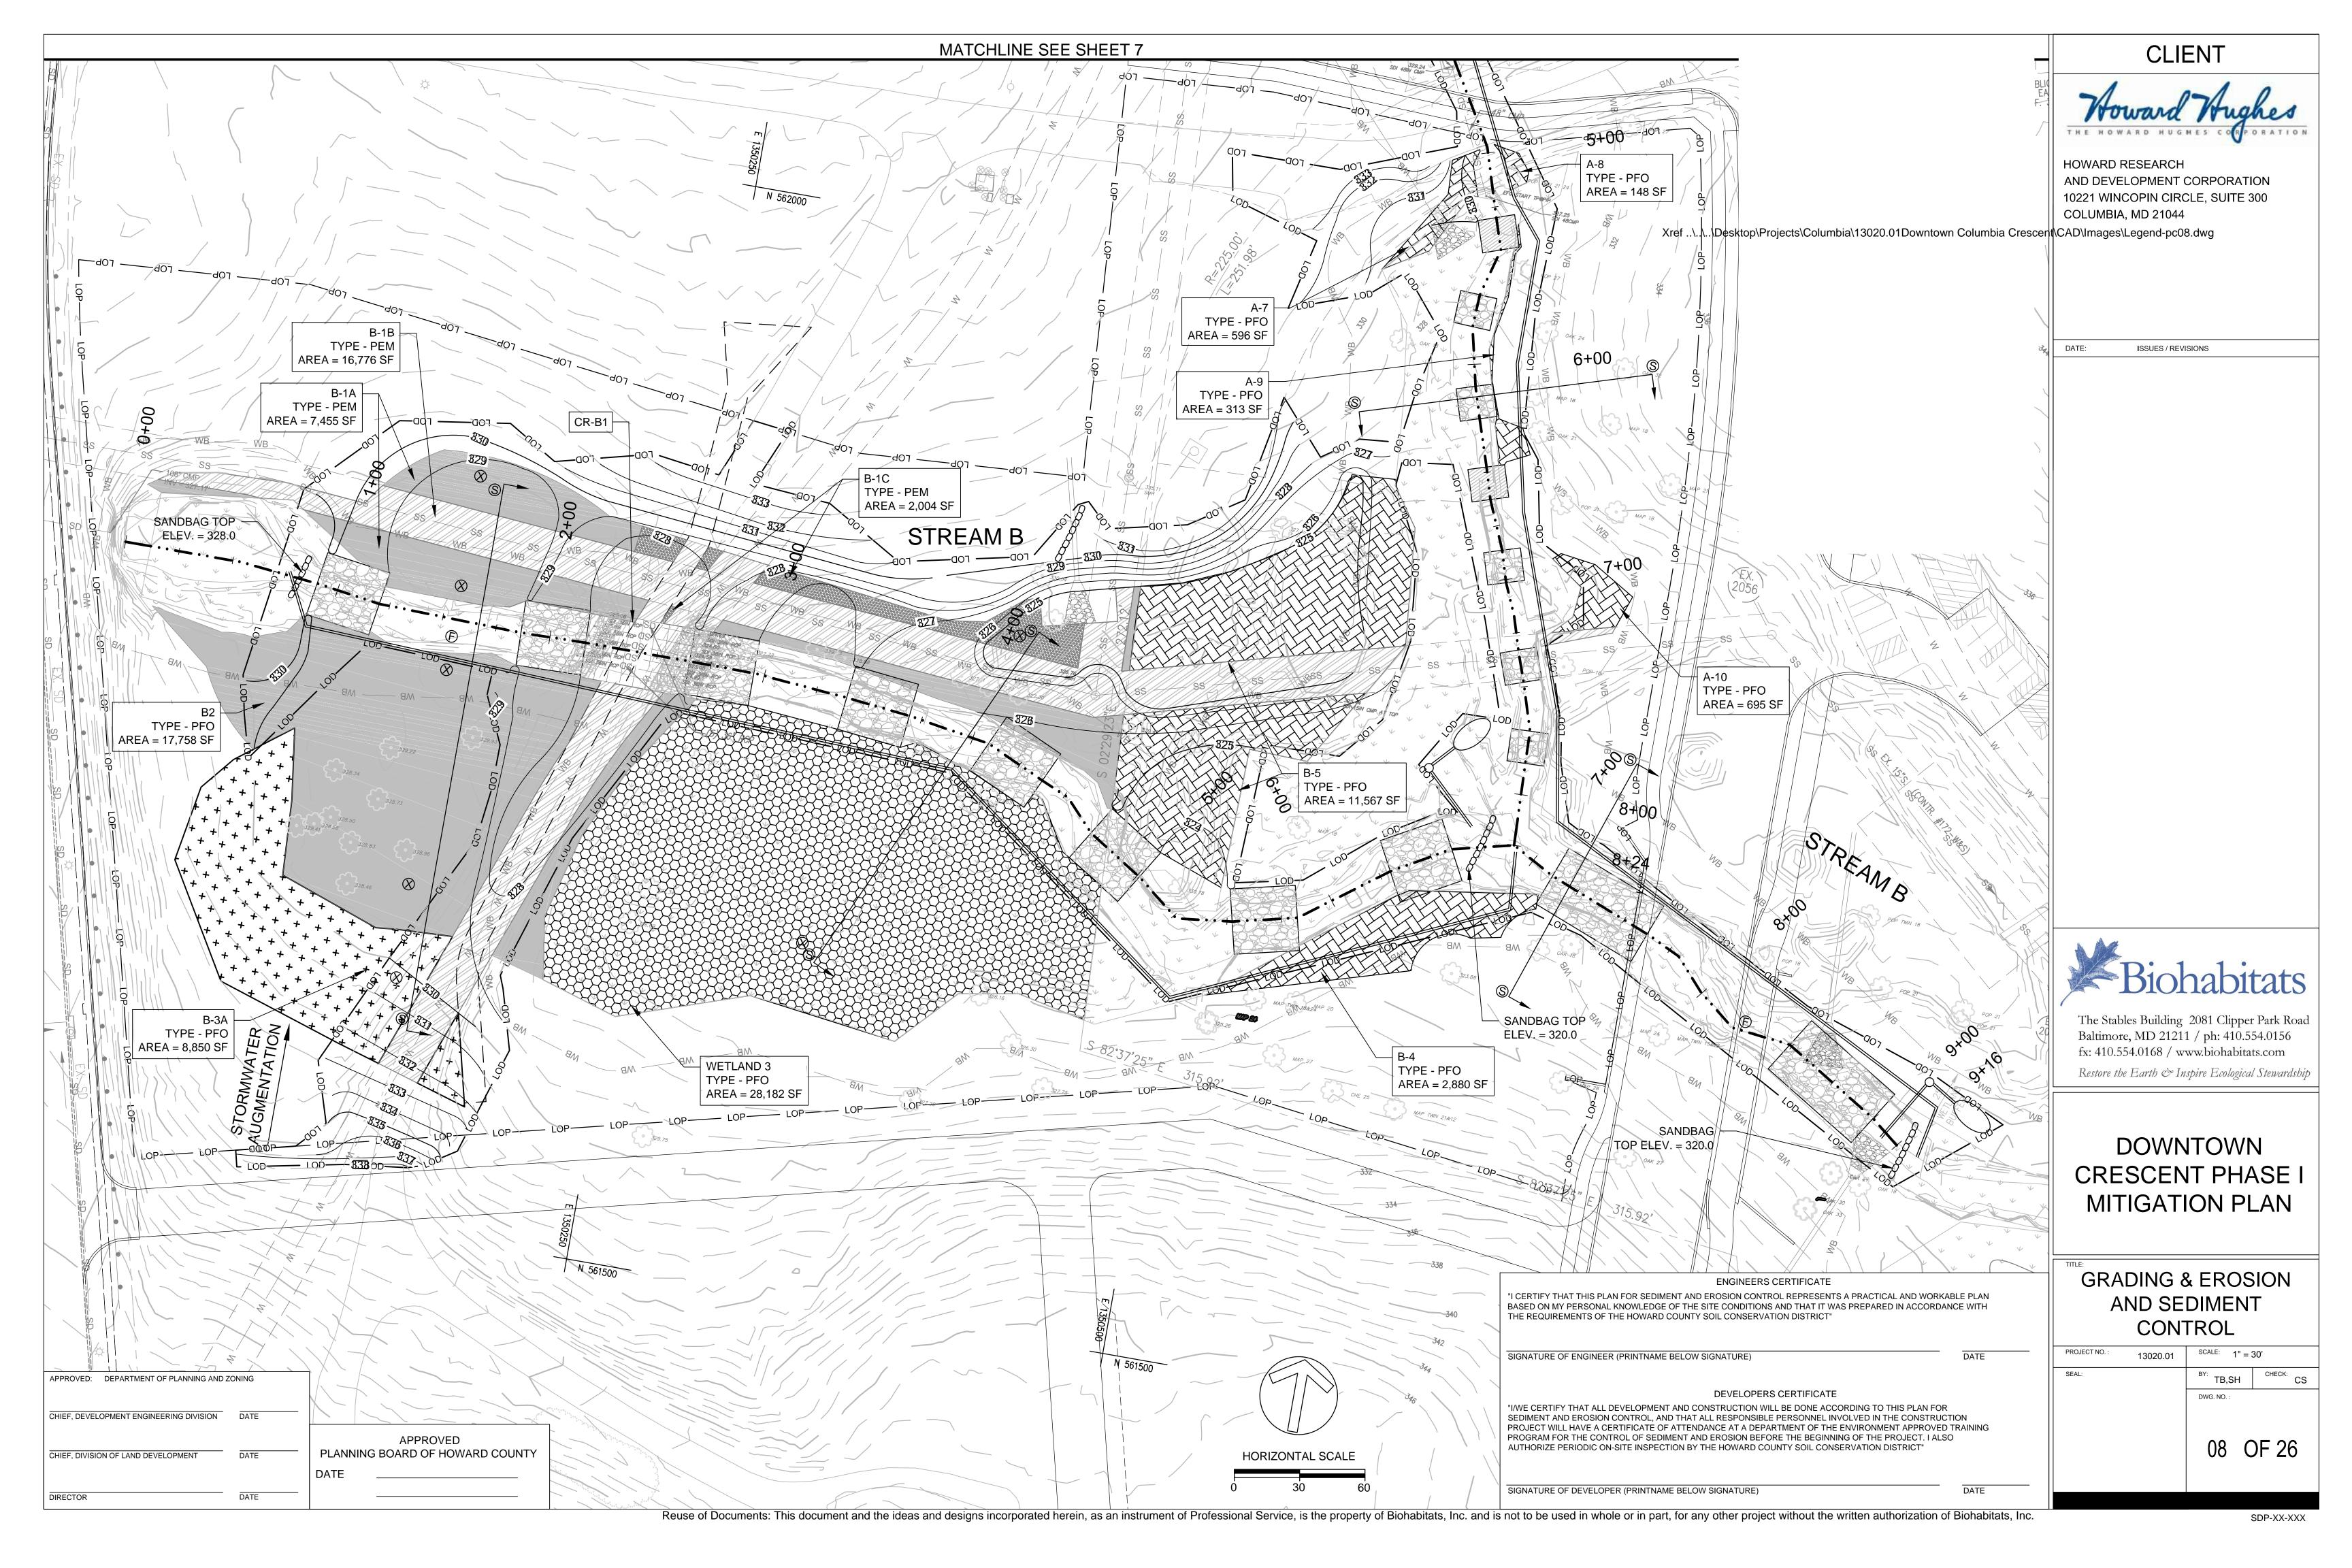


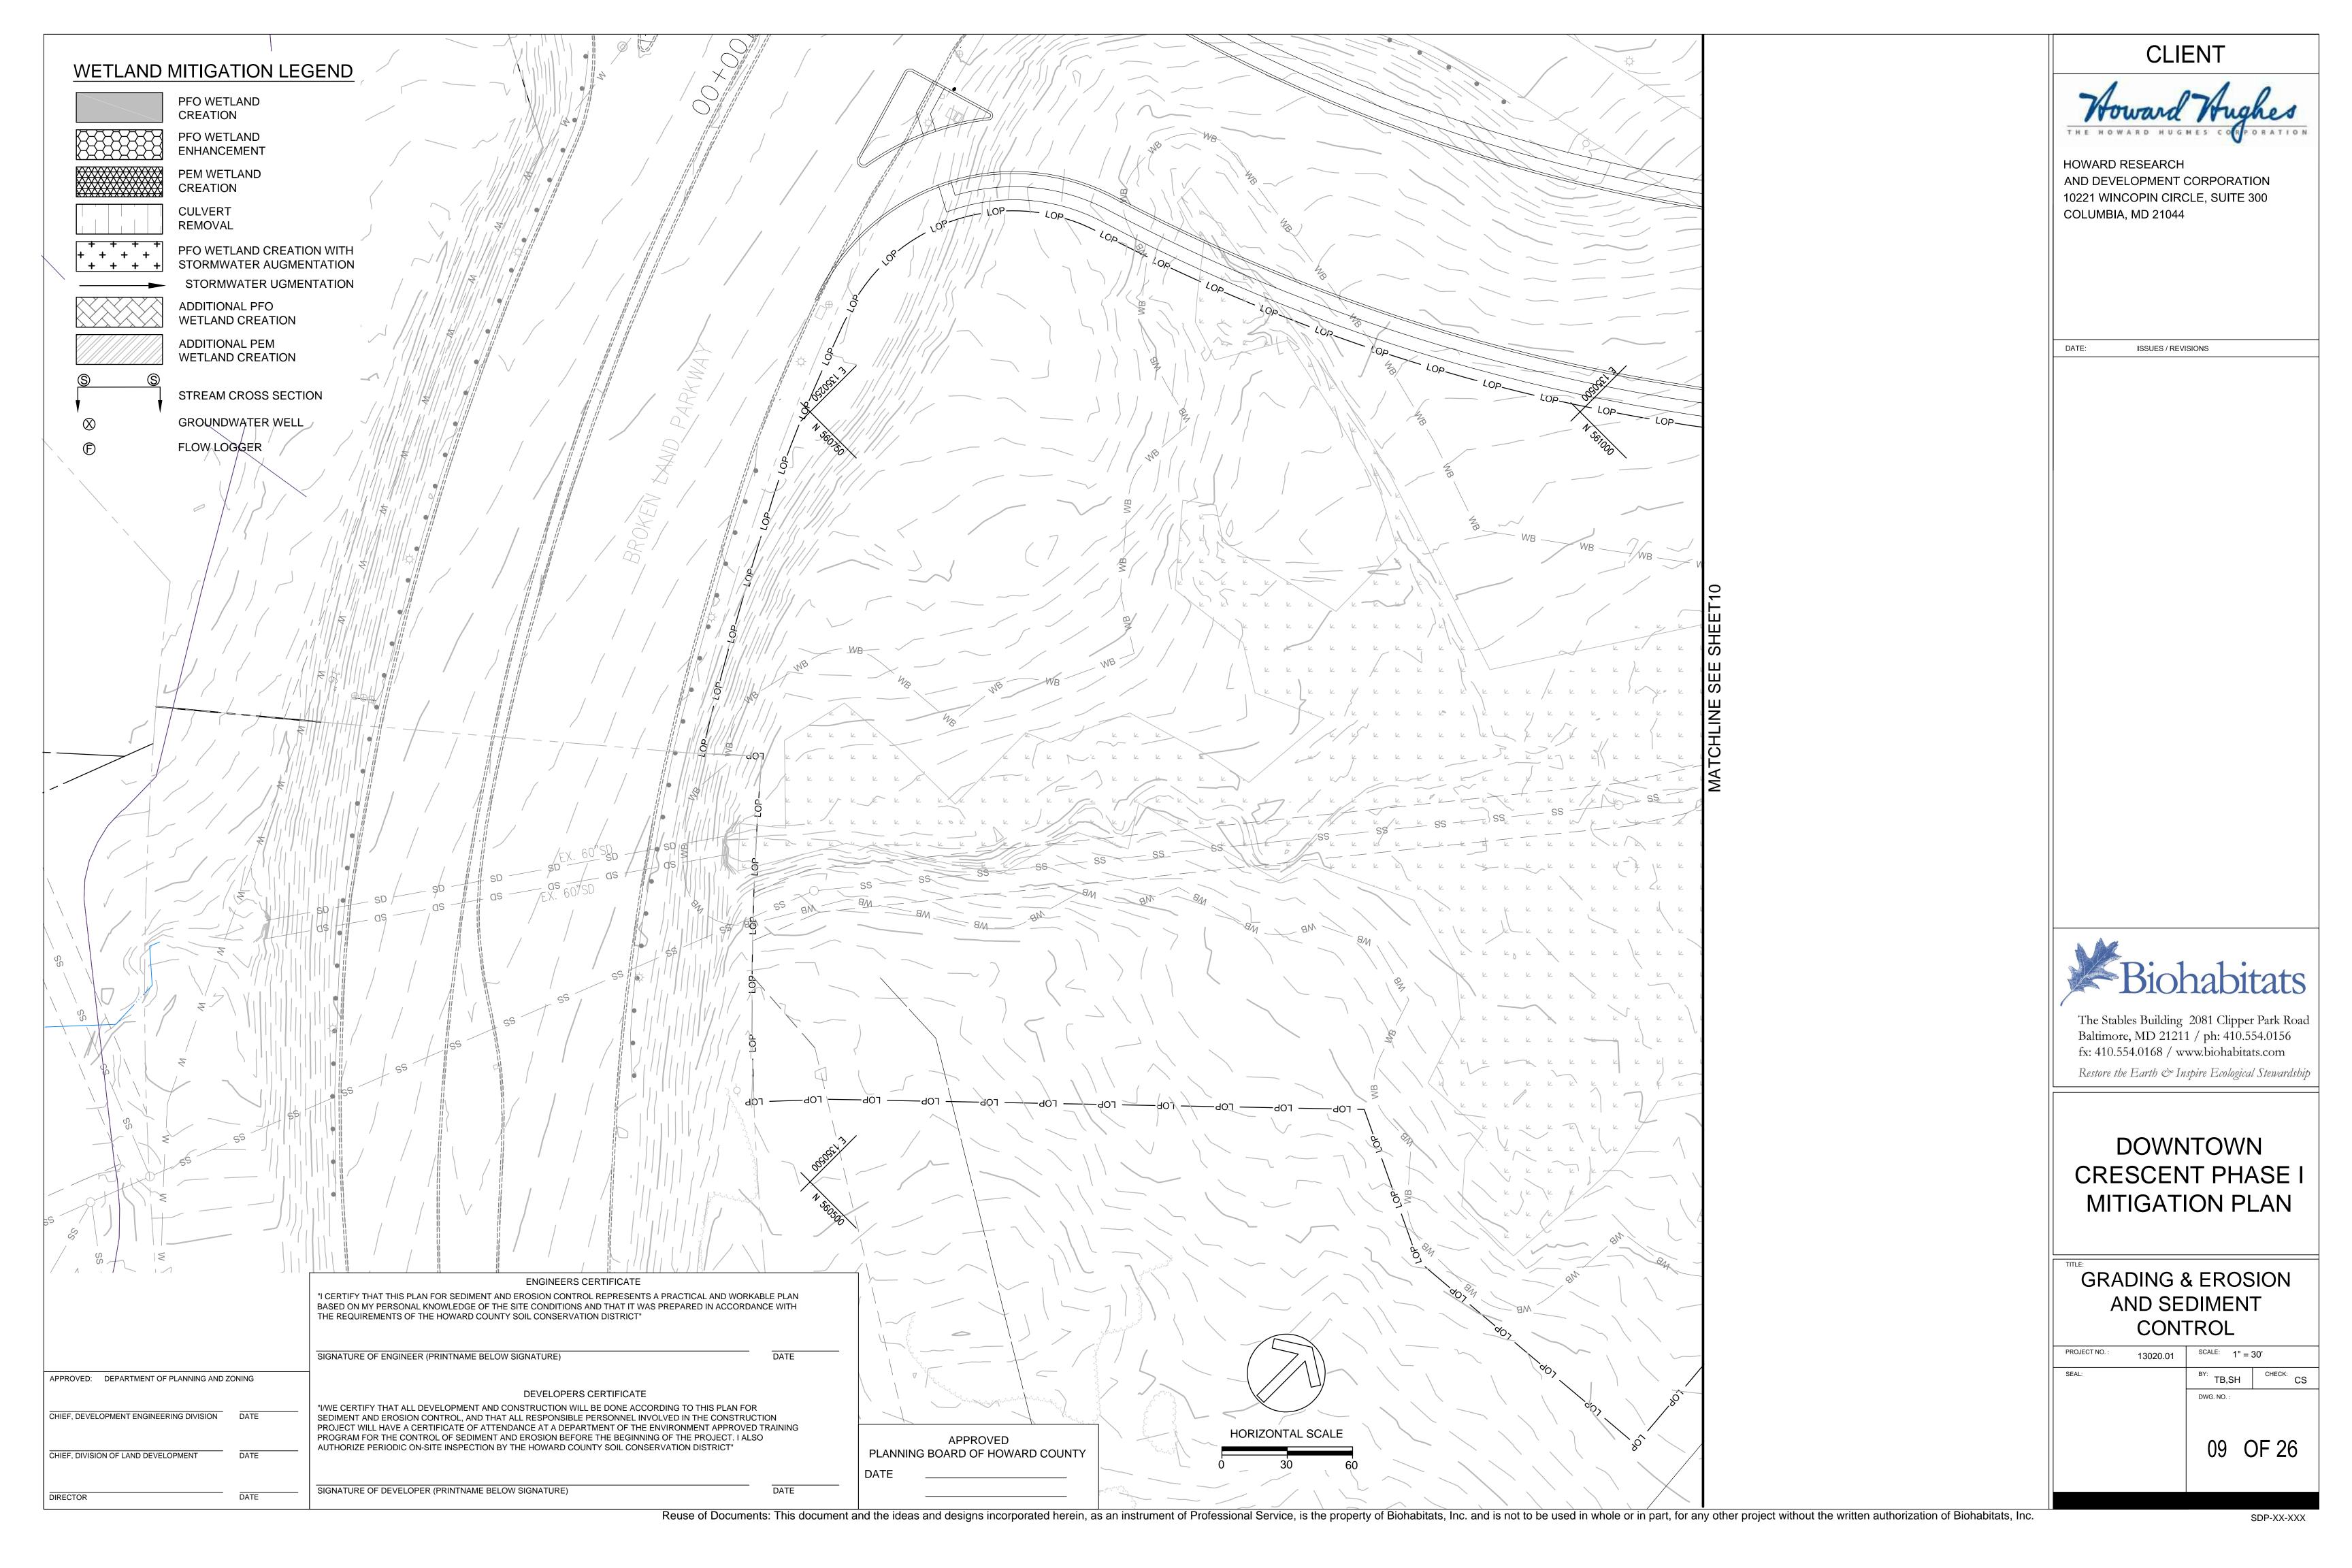

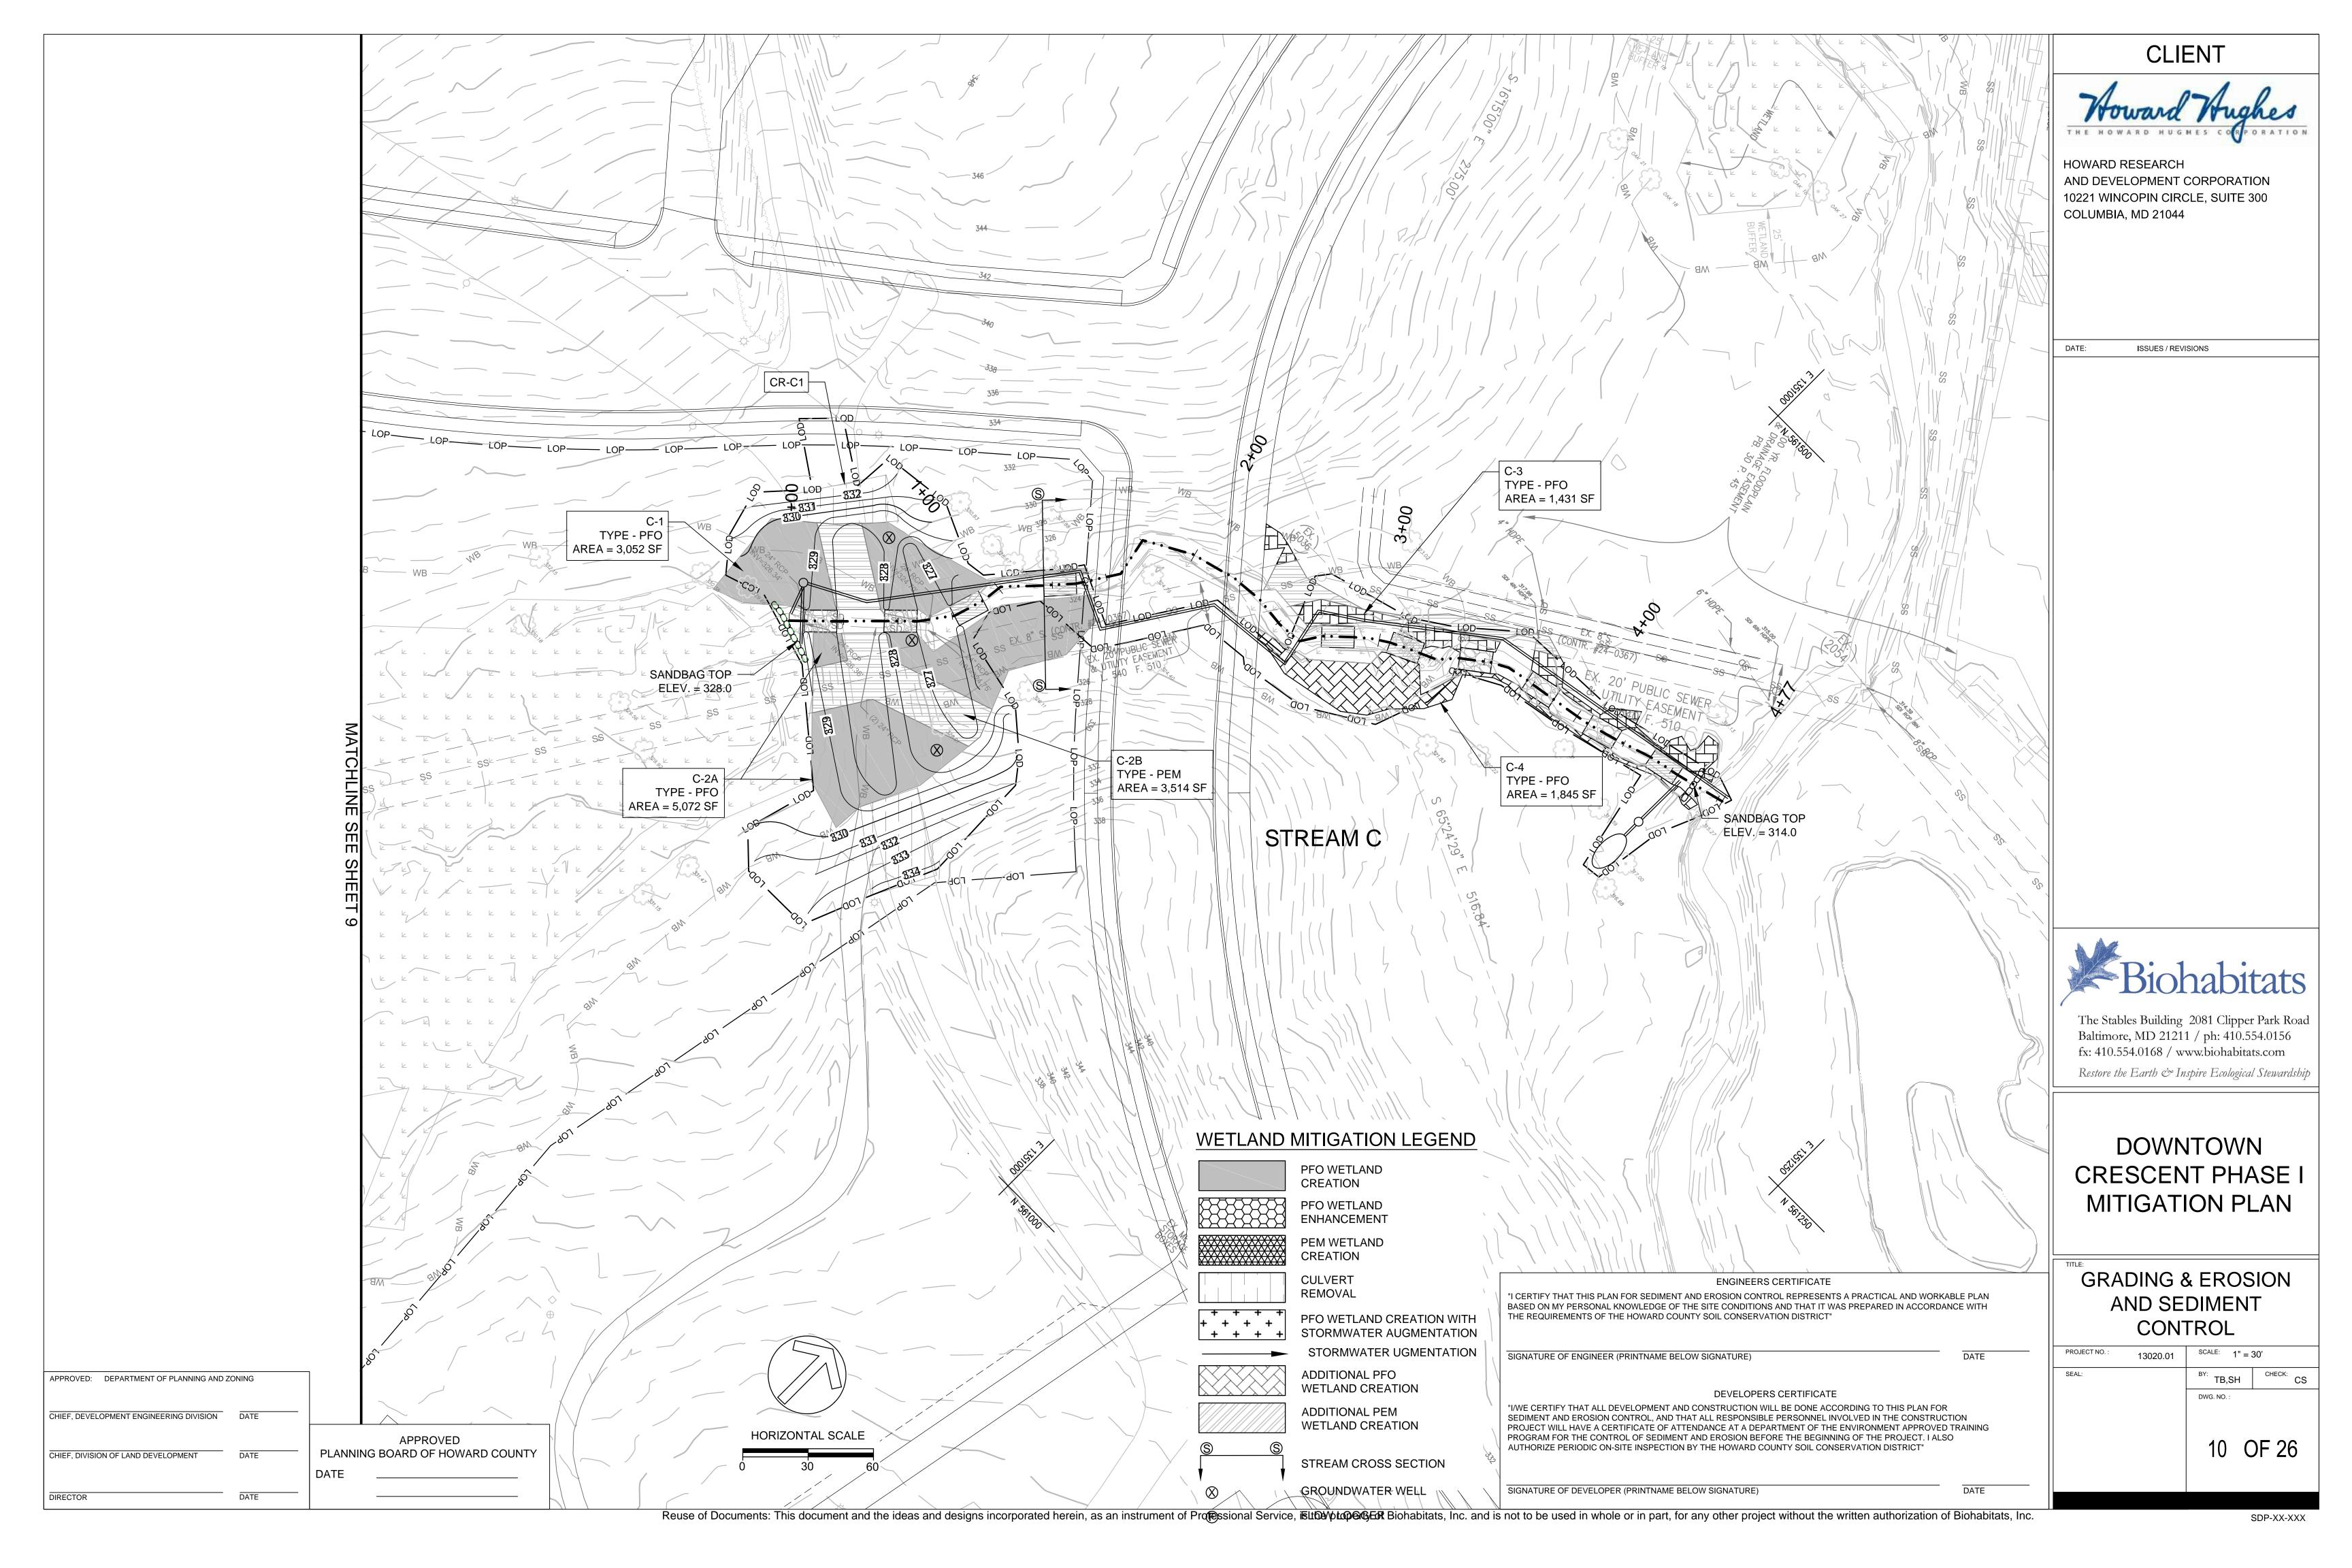

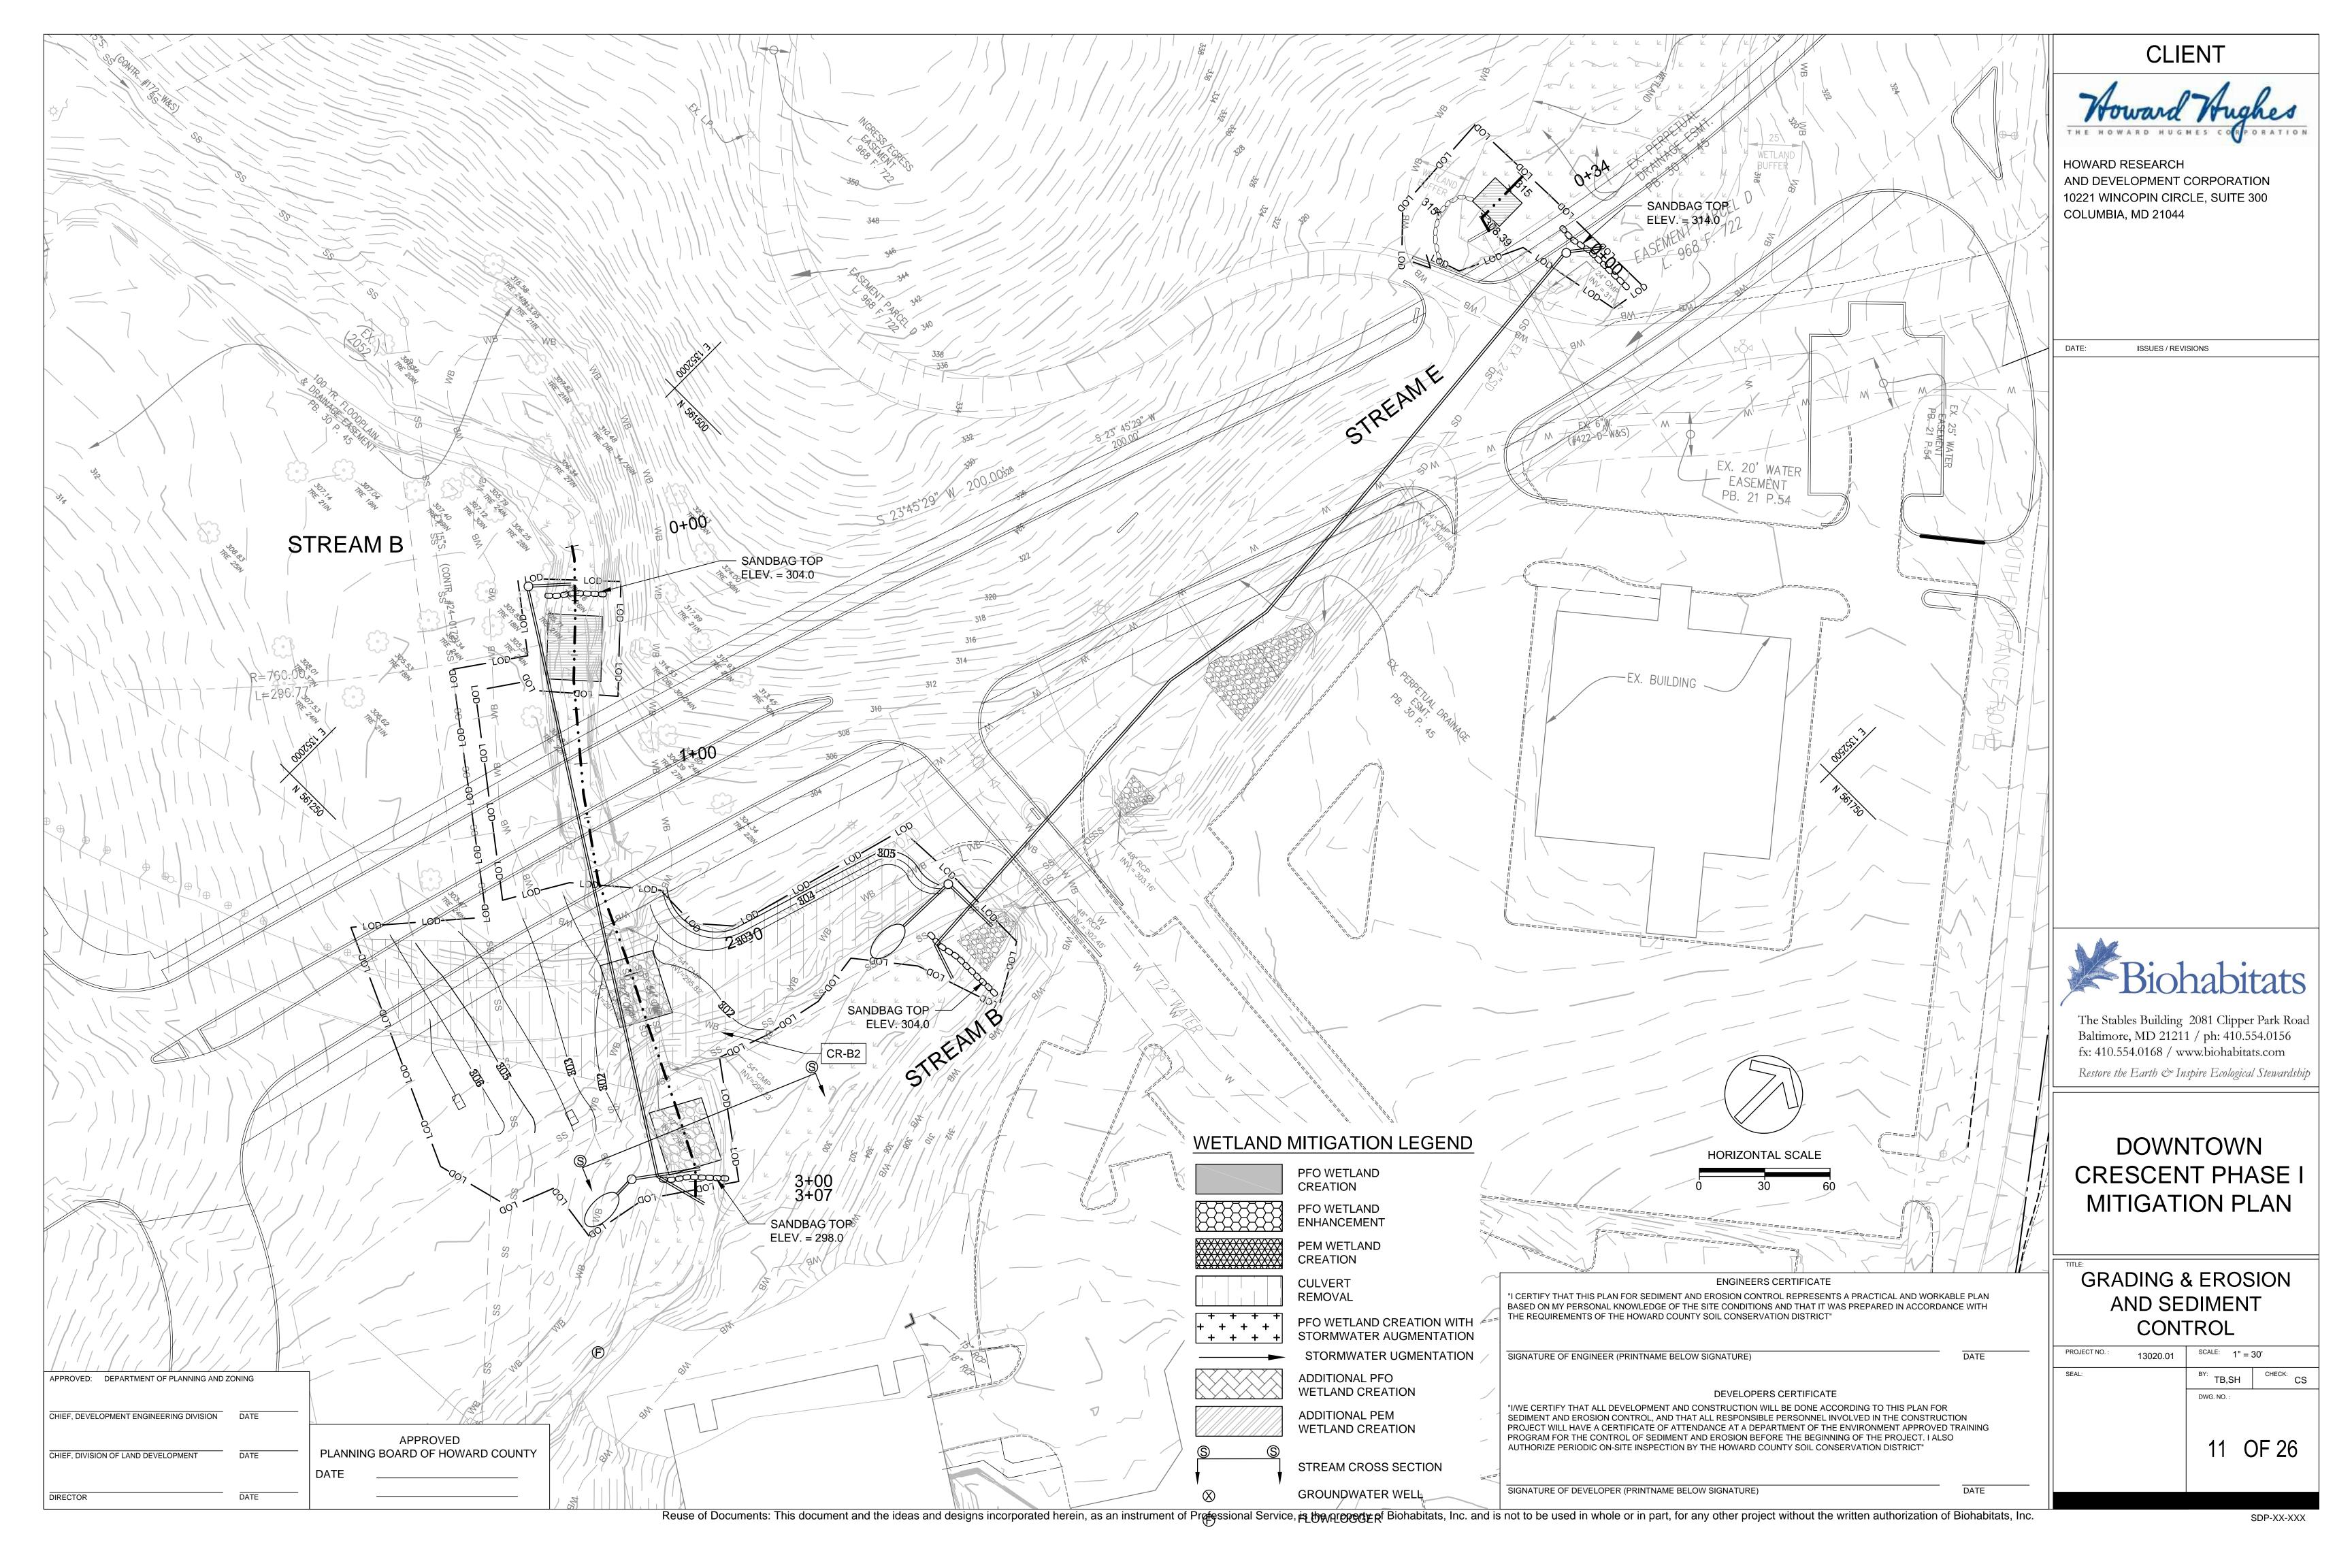


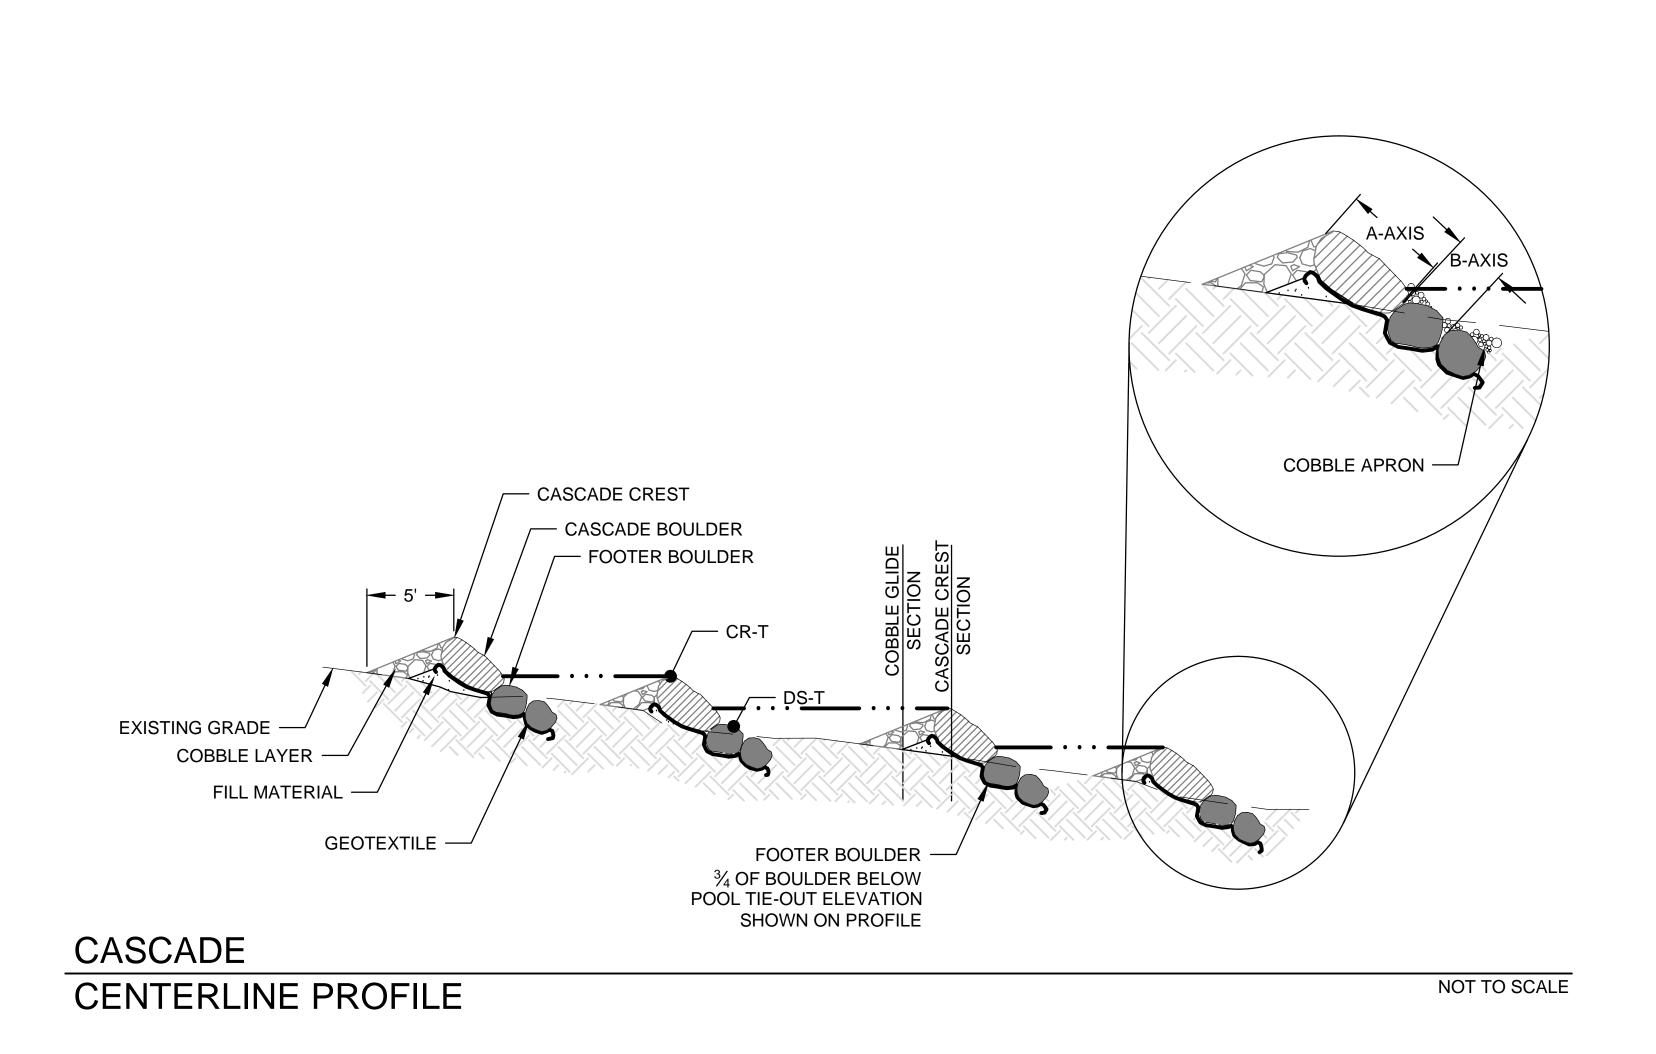

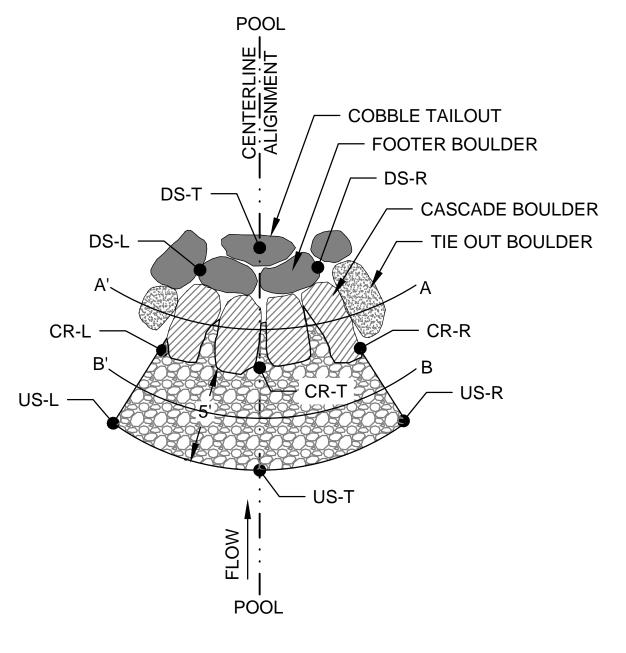


CASCADE PLAN VIEW

NOT TO SCALE

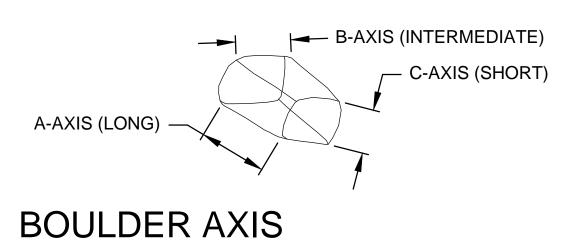

NOT TO SCALE

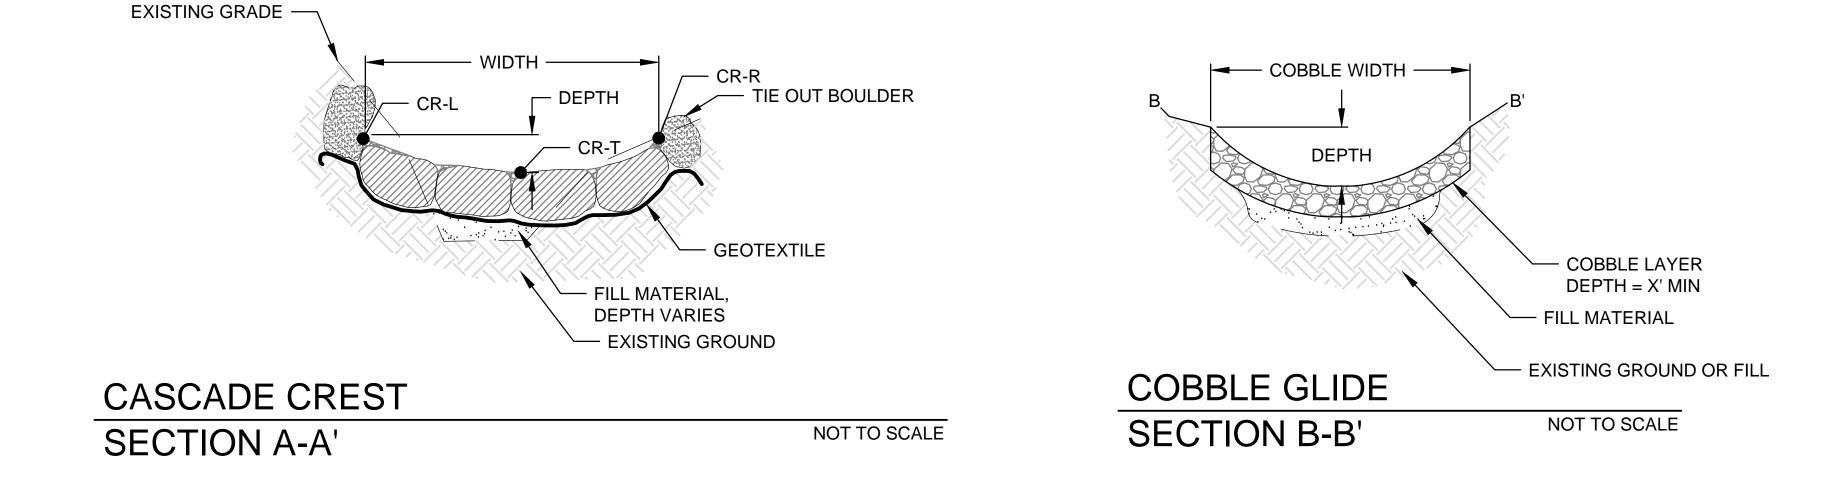

| | BOULDER [| DIMENSION | S |
|---------|-----------|-----------|--------|
| | A-AXIS | B-AXIS | C-AXIS |
| CASCADE | | | |
| FOOTER | | | |
| ΓΙΕ-OUT | | | |

NOTES

- 1. GAPS BETWEEN BOULDERS SHALL BE CHINKED WITH COBBLE
- 2. TYPICALLY, CASCADE BOULDER A-AXIS WILL BE ORIENTED IN DIRECTION OF FLOW FOOTER BOULDERS A-AXIS WILL BE ORIENTED PERPENDICULAR TO FLOW.
- 3. SEE SPECIFICATIONS FOR COBBLE SIZE AND DEPTH



CLIENT

AND DEVELOPMENT CORPORATION

10221 WINCOPIN CIRCLE, SUITE 300

ISSUES / REVISIONS

HOWARD RESEARCH

COLUMBIA, MD 21044

The Stables Building 2081 Clipper Park Road Baltimore, MD 21211 / ph: 410.554.0156 fx: 410.554.0168 / www.biohabitats.com

Restore the Earth & Inspire Ecological Stewardship

DOWNTOWN CRESCENT PHASE I

MITIGATION PLAN

DETAILS

15 OF 26

ENGINEERS CERTIFICATE

"I CERTIFY THAT THIS PLAN FOR SEDIMENT AND EROSION CONTROL REPRESENTS A PRACTICAL AND WORKABLE PLAN BASED ON MY PERSONAL KNOWLEDGE OF THE SITE CONDITIONS AND THAT IT WAS PREPARED IN ACCORDANCE WITH THE REQUIREMENTS OF THE HOWARD COUNTY SOIL CONSERVATION DISTRICT*

SIGNATURE OF ENGINEER (PRINTNAME BELOW SIGNATURE)

DEVELOPERS CERTIFICATE

"IWE CERTIFY THAT ALL DEVELOPMENT AND CONSTRUCTION WILL BE DONE ACCORDING TO THIS PLAN FOR SEDIMENT AND EROSION CONTROL, AND THAT ALL RESPONSIBLE PERSONNEL INVOLVED IN THE CONSTRUCTION PROJECT WILL HAVE A CERTIFICATE OF ATTENDANCE AT A DEPARTMENT OF THE ENVIRONMENT APPROVED TRAINING PROGRAM FOR THE CONTROL OF SEDIMENT AND EROSION BEFORE THE BEGINNING OF THE PROJECT. I ALSO AUTHORIZE PERIODIC ON-SITE INSPECTION BY THE HOWARD COUNTY SOIL CONSERVATION DISTRICT*

SIGNATURE OF DEVELOPER (PRINTNAME BELOW SIGNATURE)

DATE


DATE

SIGNATURE OF DEVELOPER (PRINTNAME BELOW SIGNATURE)

DATE

APPROVED
PLANNING BOARD OF HOWARD COUNTY

DATE

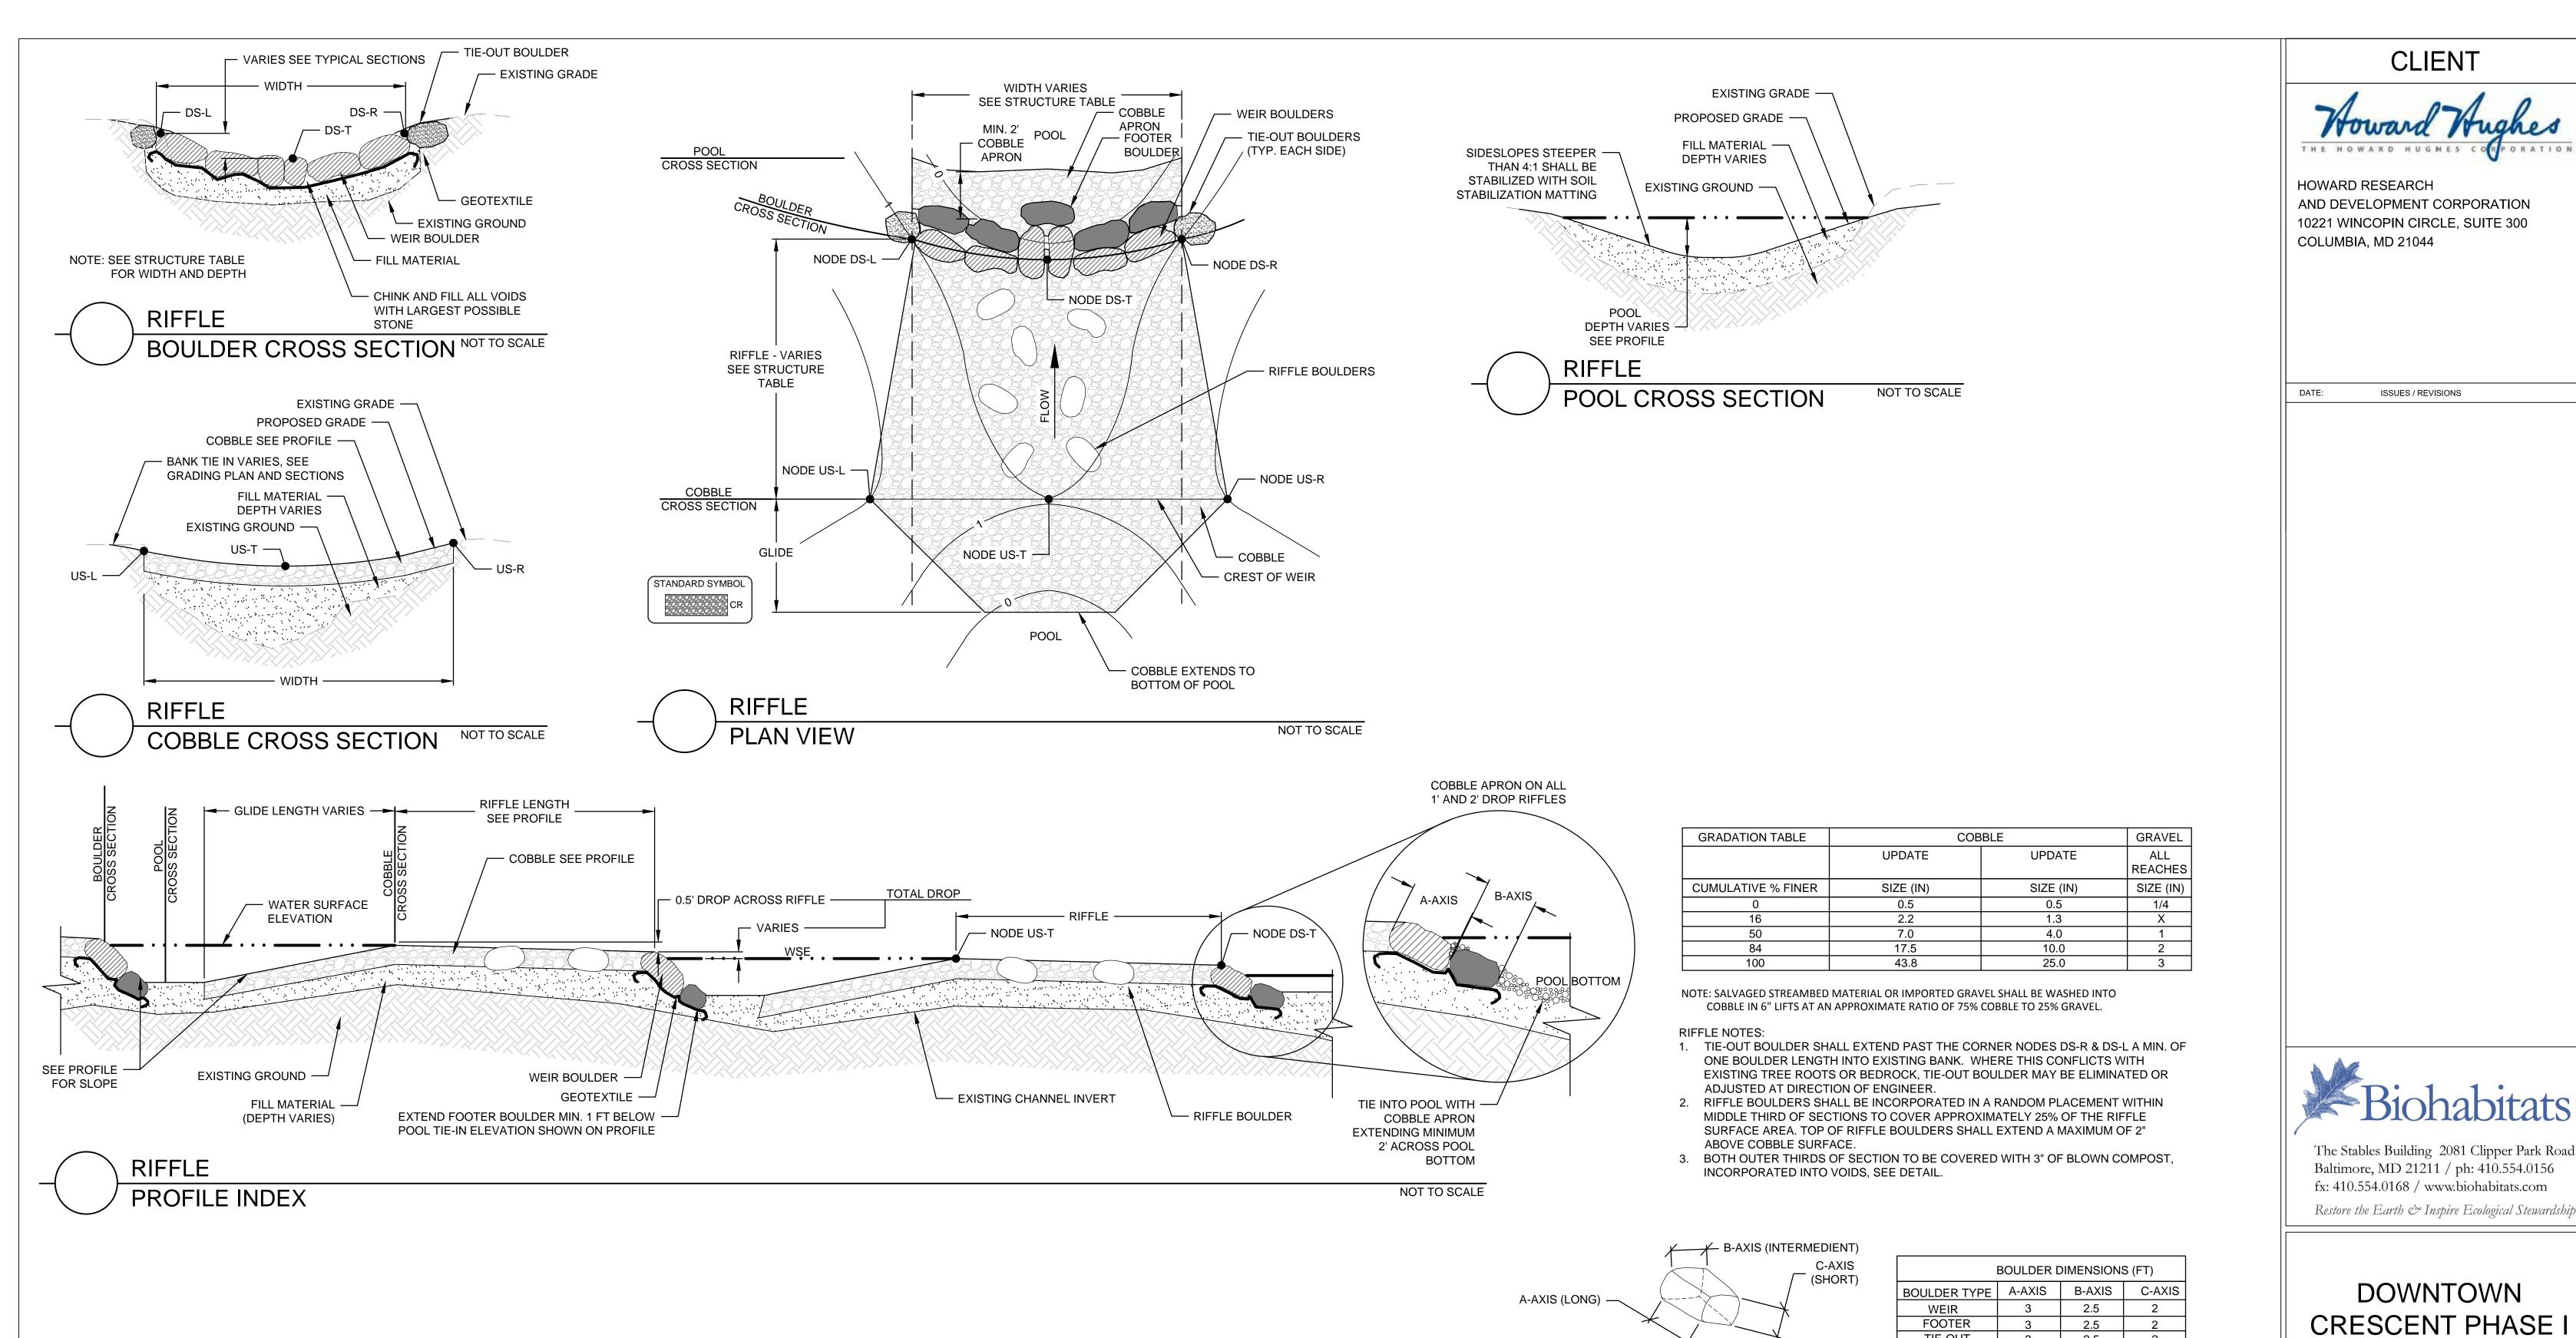

APPROVED

PLANNING BOARD OF HOWARD COUNTY

DATE

ENGINEERS CERTIFICATE

DEVELOPERS CERTIFICATE

"I CERTIFY THAT THIS PLAN FOR SEDIMENT AND EROSION CONTROL REPRESENTS A PRACTICAL AND WORKABLE PLAN

BASED ON MY PERSONAL KNOWLEDGE OF THE SITE CONDITIONS AND THAT IT WAS PREPARED IN ACCORDANCE WITH

"I/WE CERTIFY THAT ALL DEVELOPMENT AND CONSTRUCTION WILL BE DONE ACCORDING TO THIS PLAN FOR

PROGRAM FOR THE CONTROL OF SEDIMENT AND EROSION BEFORE THE BEGINNING OF THE PROJECT. I ALSO

AUTHORIZE PERIODIC ON-SITE INSPECTION BY THE HOWARD COUNTY SOIL CONSERVATION DISTRICT"

SEDIMENT AND EROSION CONTROL, AND THAT ALL RESPONSIBLE PERSONNEL INVOLVED IN THE CONSTRUCTION PROJECT WILL HAVE A CERTIFICATE OF ATTENDANCE AT A DEPARTMENT OF THE ENVIRONMENT APPROVED TRAINING

THE REQUIREMENTS OF THE HOWARD COUNTY SOIL CONSERVATION DISTRICT"


SIGNATURE OF ENGINEER (PRINTNAME BELOW SIGNATURE)

SIGNATURE OF DEVELOPER (PRINTNAME BELOW SIGNATURE)


APPROVED: DEPARTMENT OF PLANNING AND ZONING

CHIEF, DEVELOPMENT ENGINEERING DIVISION


CHIEF, DIVISION OF LAND DEVELOPMENT

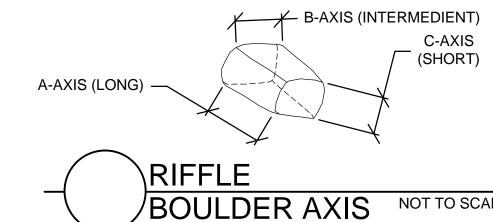


| | BOULDER [| DIMENSIONS | S (FT) |
|--------------|-----------|------------|--------|
| BOULDER TYPE | A-AXIS | B-AXIS | C-AXIS |
| WEIR | 3 | 2.5 | 2 |
| FOOTER | 3 | 2.5 | 2 |
| TIE-OUT | 3 | 2.5 | 2 |
| SPLASH | 3 | 2.5 | 2 |
| RIFFLE | 3 | 2.5 | 2 |
| | | | |

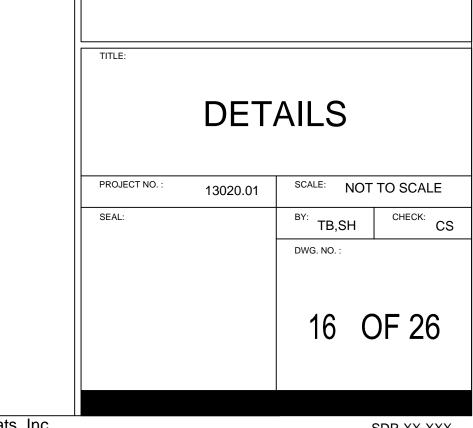

MITIGATION PLAN

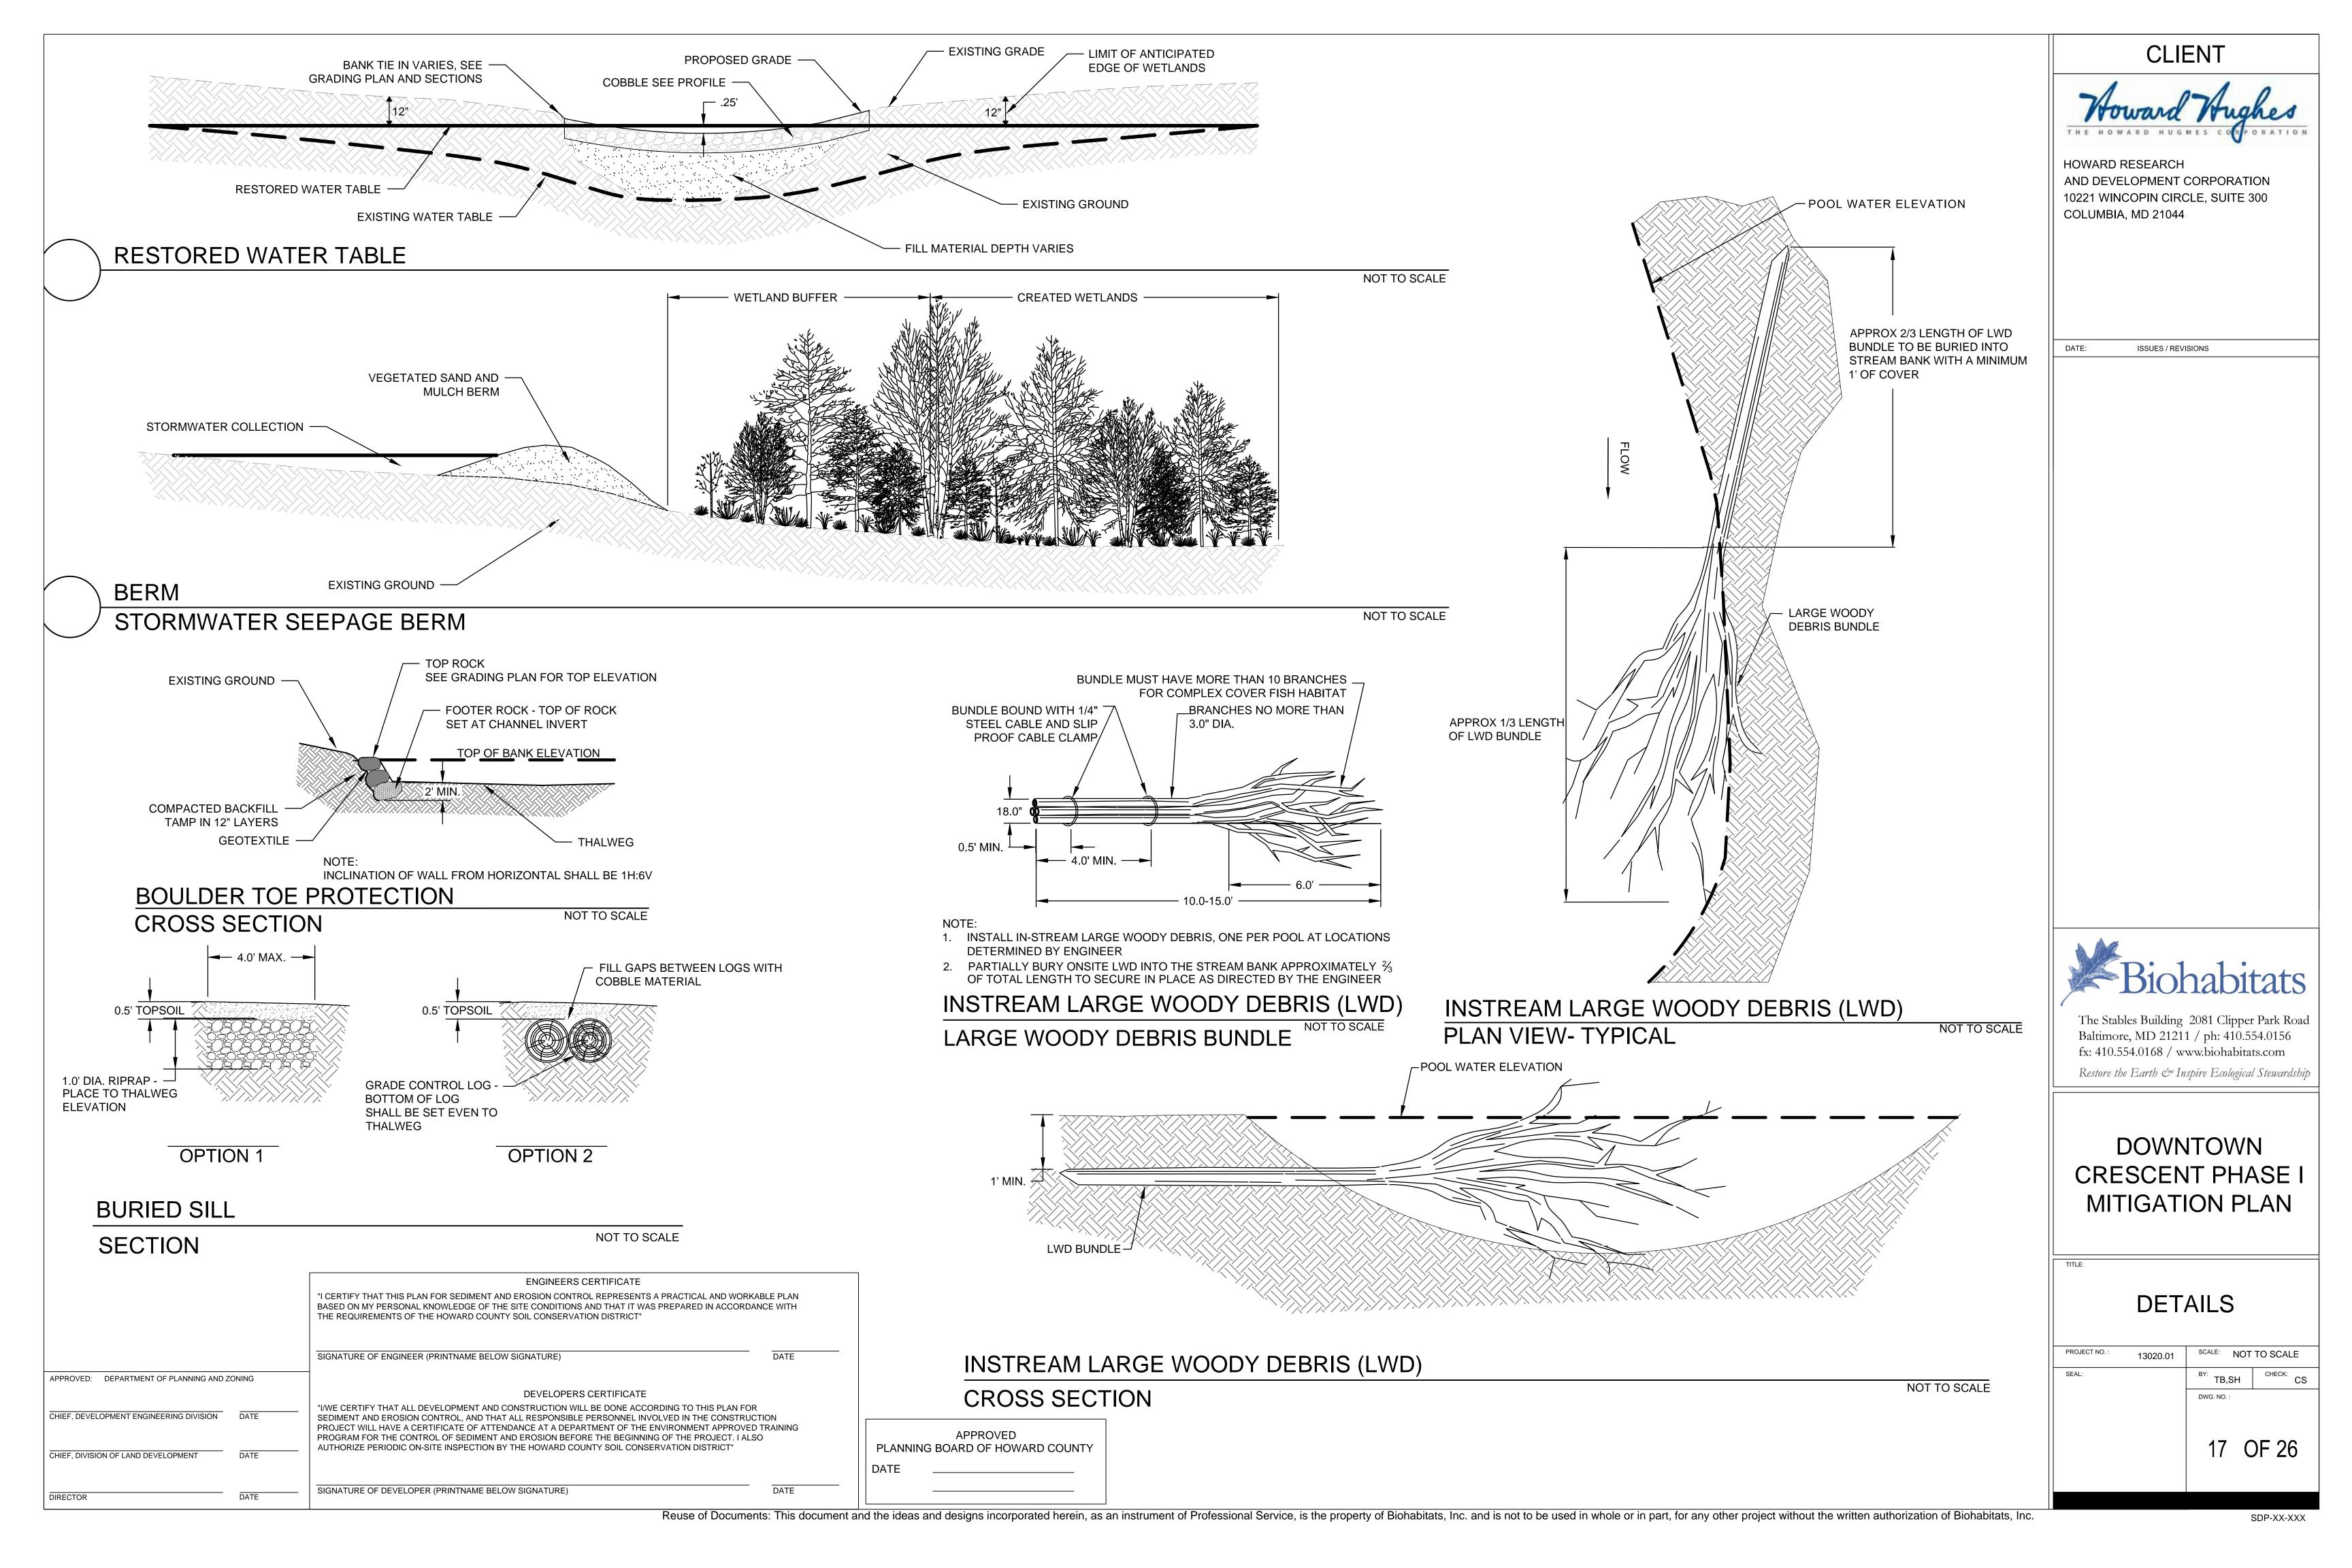




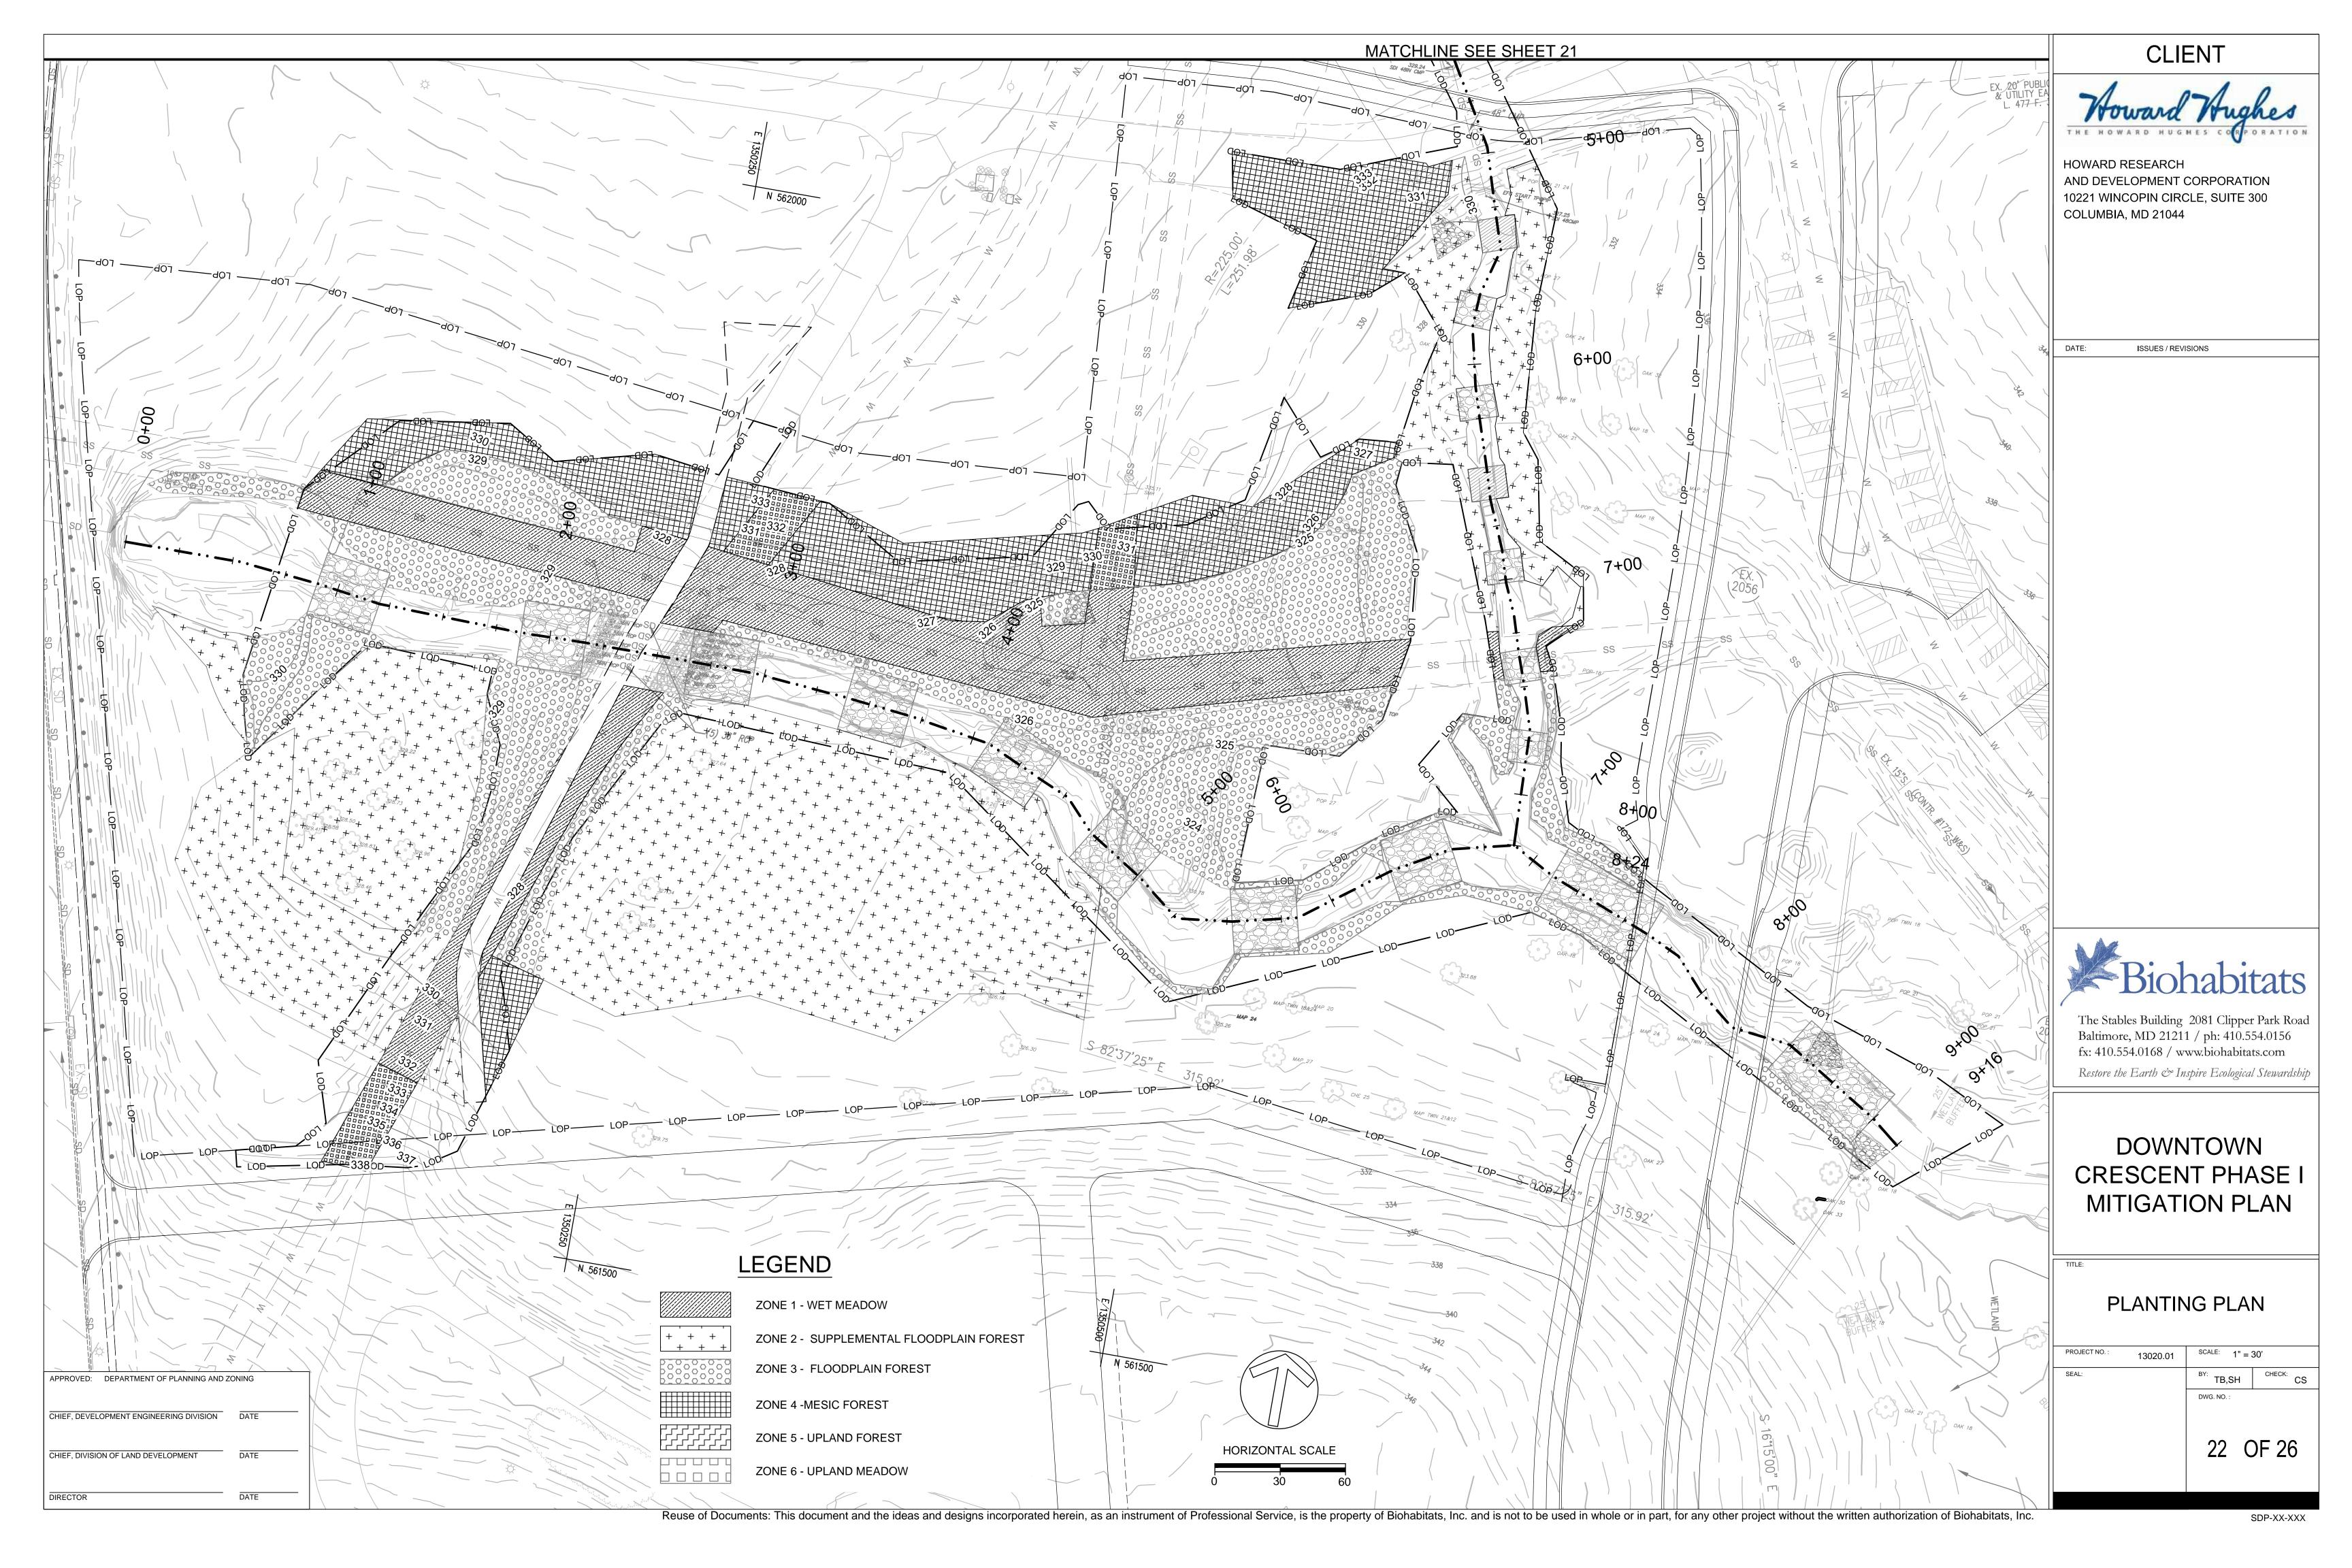





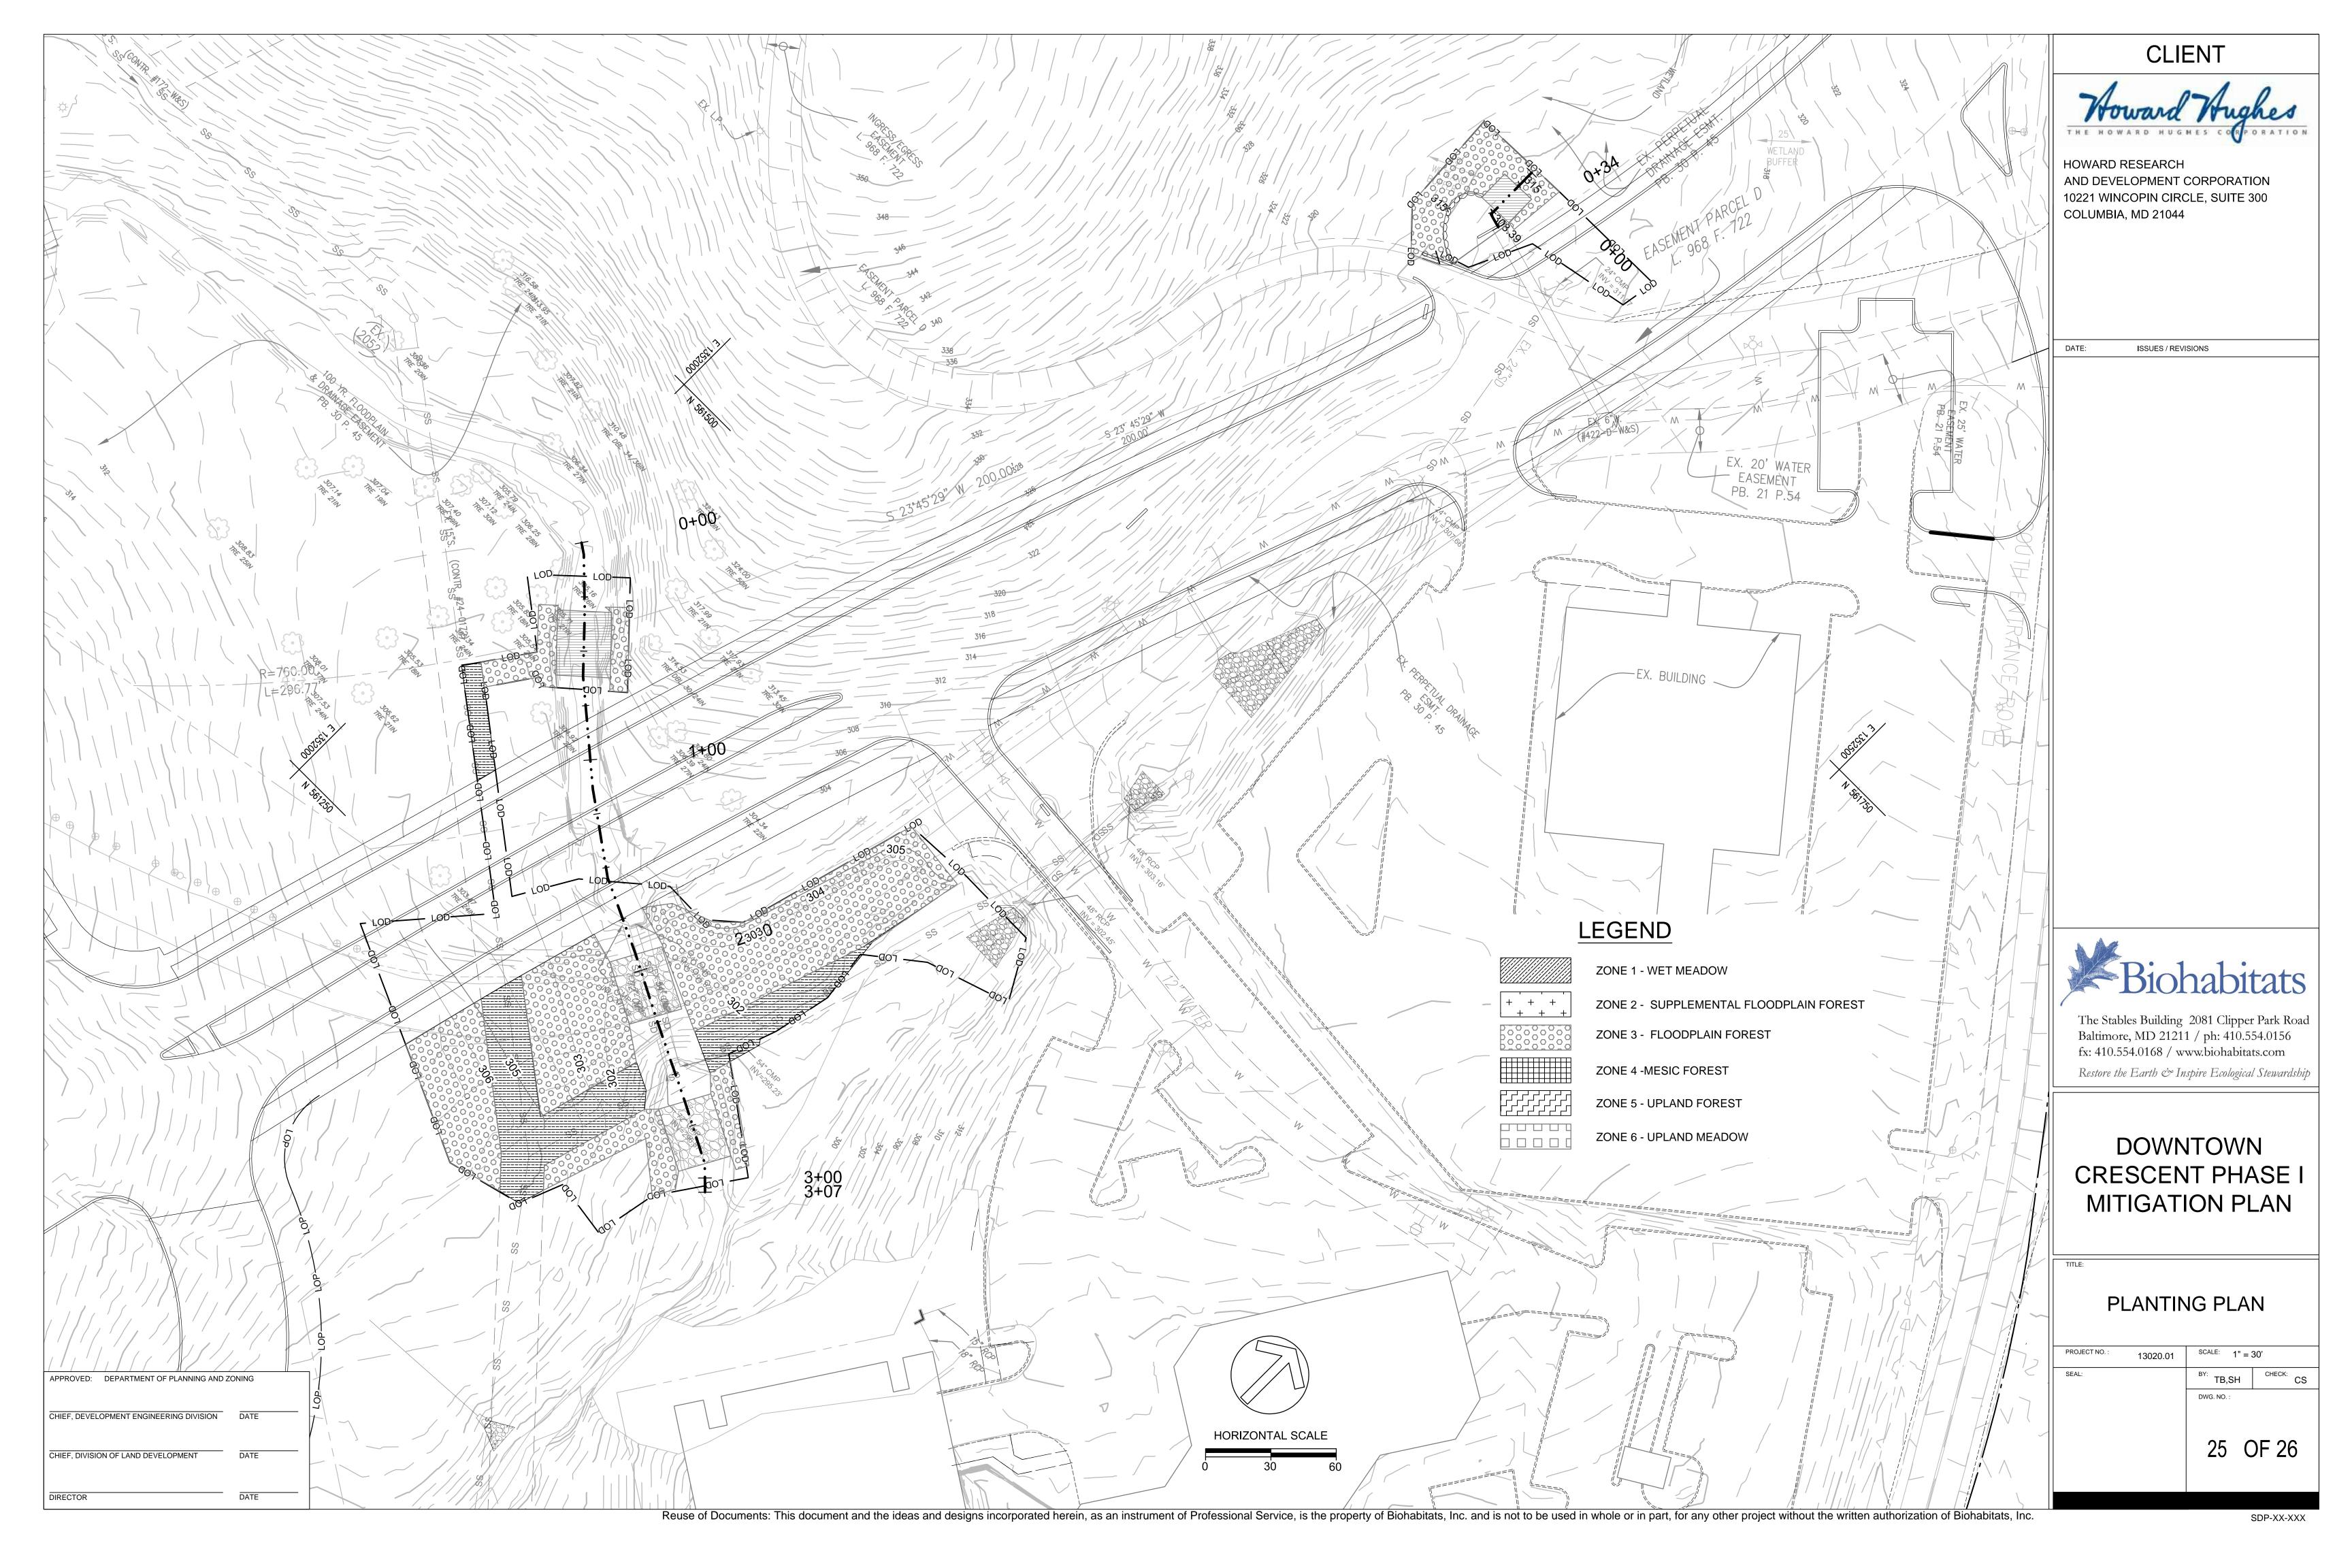

Resource Impact Tabulation Chart Columbia Crescent


| Mitigation to be provided 53,857** | Mitigation required 34,375* | TOTALS | Emergent 1,979 | Forested 16,198 | DEVELOPMENT IMPACT TOTALS | | | Area 6 | | | | | Area 2 | | e individual de la companya de la c | | | Storm Drains (North and Middle) | Crossing 4 5,146 (FO) | | | Crossing 7, Storm Drain, Grading for NS Connector 7,661 (FO) | Crossing 6 249 (FO) | Crossing 5, Water and Sewer Relocation 0 | Pedestrain Boardwalk 0 | | | Crossing 3 | Hickory Ridge Extension 1,979 (EM) | Crossing 2, Water Line & Storm Drains 0 | Pedestrian Boardwalk 0 | Area 1 Storm Drain 113 (FO) | Crossing 1 3,029 (FO) | | | PERM | DESIGNATION | |
|------------------------------------|-----------------------------|--------------|----------------|-----------------|---------------------------|-----------|--|--|------------|-------------|------------|-------------|-------------|-------------|--|--|-----|---------------------------------|-----------------------|-----------|--|--|---------------------|--|------------------------|----------|-------------------------------------|------------|------------------------------------|---|------------------------|-----------------------------|-----------------------|--------|--|------|---------------|--|
| 0 | 0 | 19 | 0 | 3,685 | 3,000 | 2 695 | | 0 | 430 (FO) | 1,725 (FO)A | 1 723 (EO) | 2.494 (FO)^ | 8.643 (FO)^ | 5.843 (EO)^ | | | 0 | 0 |)) 2,214 (FO) | | |)) 218 (FO) | 159(FO) | 0 | 1,471 (FO) | | The second second | 0 | 0 | 0 | 0 | 0 | 0 | | SHEET THE SECOND | TEMP | (SF) | |
| 0 | 0 | ° | 0 | | 324.50 | 35 422 | | U | | | 0 | 0 | 0 | 0 | Mitigation Impacts | | 0 | 95 | 10,301 | PHASE III | 2000 | 8,081 | 1,790 | _ | , | PHASE II | | 0 | 6,077 | 0 | 0 | 165 | 8,913 | PHASE | · 一選を持ちたというというというというというというというというというというというというというと | PERM | IMPACIS (SF) | |
| 0 | ° | 19,429 | 0 | - | 0,071 | 5 641 | | 0 | 2 | 3 101 | 3 291 | 3,718 | 8,221 | 1.098 | acts | 1. NOT 1. SECTION 1. S | 0 | 2,548 | 2,441 | | | 40 | С | | 612 | | Total Carlotte | 0 | 0 | 0 | 0 | 0 | 0 | | | TEMP | o (or) | |
| 1,828 | 975/1,397 | | ٥ | | , , , | 975/1.397 | | Contraction of the contraction o | | 0 | 0 | 0 | 0 | 0 | | | 0 | 0 | 553/553 | | BORNE STOCKE STO | 311/622 | 222/111 | | 0 | , | | 0 | 0 | 0 | O | 0 | 0 | | es de la companya de | PERM | Î | |
| 0 | , - | 1,828/13,00/ | 1 00013 057 | | , | 130/130 | | A TOTAL STREET, STREET | 110/1 841^ | 215/430^ | 562/6,560^ | 262/2,886^ | 347/694^ | 323/646^ | | は、対象の大きなないのでは、 | 0 | 0 | 130/130^ | | A STATE OF THE STA | 0 | | | 0 | | | 0 | C | O | | | | | Spinish continues of contra | TEMP | i.o. (Erior) | |
| c | |)# | 747 | | , | 72,925 | のできる。 | | 0 | 0 | 100 | 0 | 647 | | | | 117 | 5,458 | 6,720 | 2 400 | OFFICE | 14,024 | 9,721 | 0 721 | 12 042 | | STATE OF THE PROPERTY OF THE PARTY. | 4,9/9 | - | 4,685 | | | 13,4/8 | 10.120 | Control of the contro | PERM | | |
| 6 | , | 0 000 | 144 000 | , | | 18,829 | | | 20.558 | 21,713 | 25,209 | 37,109 | 28,138 | 12,182 | | No. of the last of | 456 | 10,820 | 3,001 | 2 654 | | 210 | 340 | 0 | 2 226 | 4 550 | AND COMPANY OF STREET OF STREET | U | | | | | | | STATE OF THE PERSON NAMED IN COLUMN TWO IS NOT THE PERSON NAMED IN THE PERSON | EMT | 9 (9) | |
| | | ١ | 3 | 3 | 0 | 31,033 | Marie Commission of the Commis | A Company of the Comp | 0 | 0 | 0 | 0 | 0 | C | | | O | 1,710 | 1 742 | 16 063 | | C,CEO | 2220 | 0 | 4 742 | D | | 2,22,2 | 000 | 0 0 | 310 | | 0,00 | 2 981 | The second secon | TENN | DEBM (COLING) | |

Revised 10/1/14

^{* 2:1} mitigation required for all impacts except Phase 2 pathway which is 0.5:1 and Hickory Ridge Extension which is 1:1.

** Mitigation includes creation of 37,762 sf forested wetlands, creation of 2,004 sf of emergent wetlands, and enhancement of 14,091 sf forested wetlands

* These impacts are classified as Permanent-No Loss by the Army Corps of Engineers

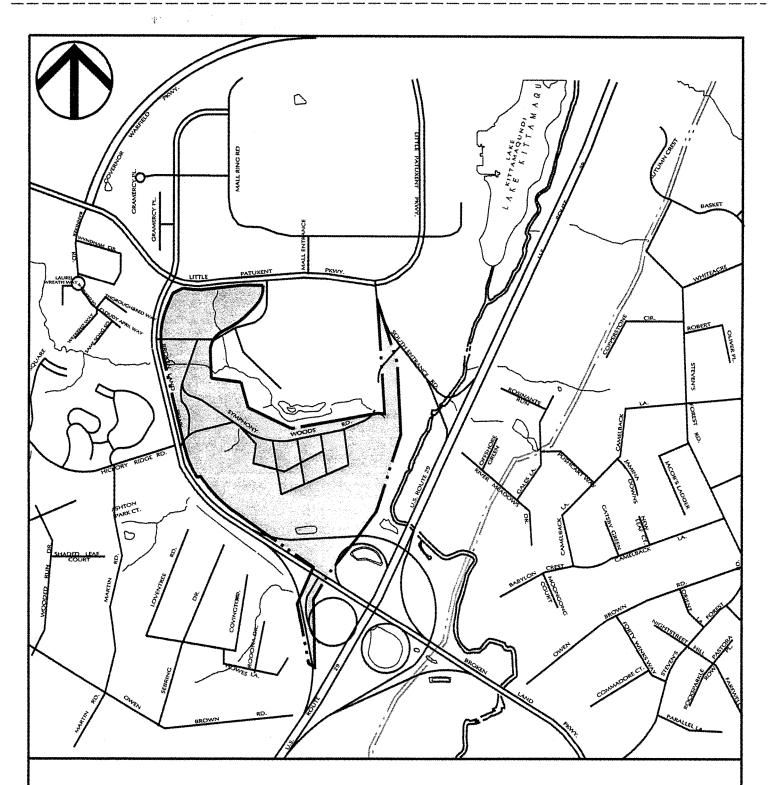

VICINITY MAP

Scale: 1"=2000'

VICINITY MAP COLUMBIA CRESCENT

BROKENLAND PARKWAY HOWARD COUNTY COLUMBIA, MARYLAND

5 ELECTION DISTRICT RW 10136 14 KMW COUNCILMANIC DISTRICT 4 Job No. 04038.A2 Scale:

Date: 07/01/14 Drawn By: GMO



DAFT MCCUNE WALKER INC

200 EAST PENNSYLVANIA AVENUE • TOWSON, MD 21286 P: 410 296 3333 F: 410 296 4705 WWW.DMW.COM

LEGEND

SUBJECT PROPERTY LINE ADJACENT PROPERTY LINE -- 580-EXISTING CONTOURS -- 582----EDGE OF PAYEMENT & OF EXISTING ROAD & OF EXISTING STREAM EXISTING TREE LINE EASEMENT LINE MbCZ SOILS LINE GcB2 W1-2 FIELD LOCATED WETLAND 1 ¥ STREAM LIMITS W1-3 25' STATE BUFFER 100-YEAR FLOODPLAIN IMPACTS TO WETLANDS (FO) -- FORESTED (EM) --EMERGENT (P)--PERMANENT (T)--TEMPORARY (T*) -- TEMPORARY (MDE), PERMANENT/NO NET LOSS (ACOE) IMPACTS TO WATERS OF THE US IMPACTS TO WETLAND BUFFERS

IMPACTS TO FLOODPLAIN

PUMP AROUND PRACTICE

SAND BAGS FOR SEDIMENT AND EROSION CONTROL

LEGEND COLUMBIA CRESCENT

BROKENLAND PARKWAY HOWARD COUNTY COLUMBIA, MARYLAND

7 ELECTION DISTRICT TW 10/50 14 HMM COUNCILMANIC DISTRICT 4

Job No. 04038.A2 Scale:


Date: 07/25/13

Drawn By: GMO



DAFT MCCUNE WALKER INC

200 EAST PENNSYLVANIA AVENUE • TOWSON, MD 21286 P: 410 296 3333 F: 410 296 4705 WWW.DMW.COM

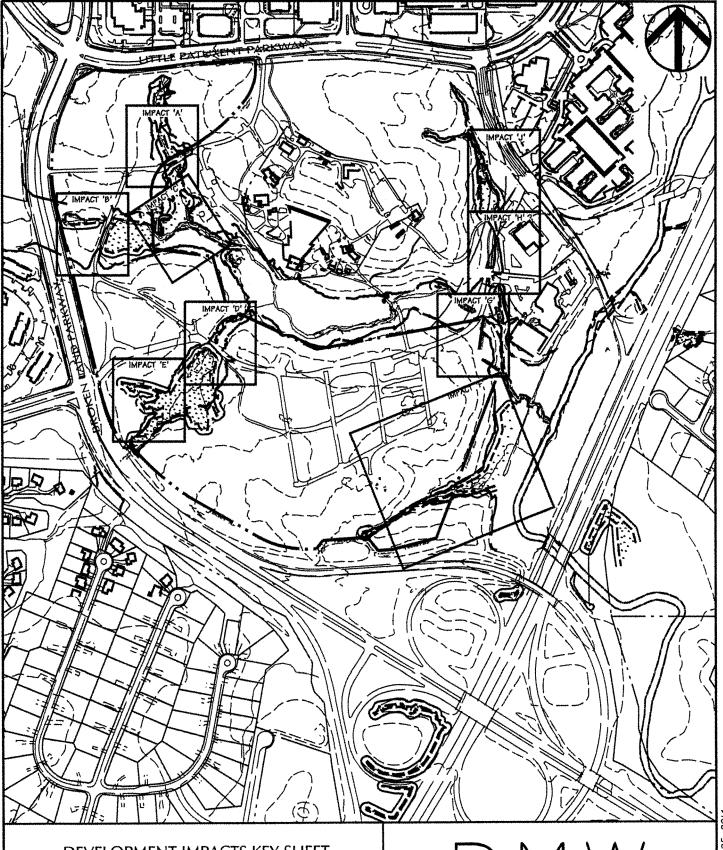

DEVELOPMENT IMPACTS KEY SHEET COLUMBIA CRESCENT

BROKENLAND PARKWAY HOWARD COUNTY COLUMBIA, MARYLAND


5 ELECTION DISTRICT REJ 10/30/14 KMM COUNCILMANIC DISTRICT 4

Job No. 04038.A2 Scale: 1"=500" Date: 7/1/14 Drawn By: HMM

DMW

DAFT MCCUNE WALKER INC

200 EAST PENNSYLVANIA AVENUE • TOWSON, MD 21286 P: 410 296 3333 F: 410 296 4705 WWW.DMW.COM

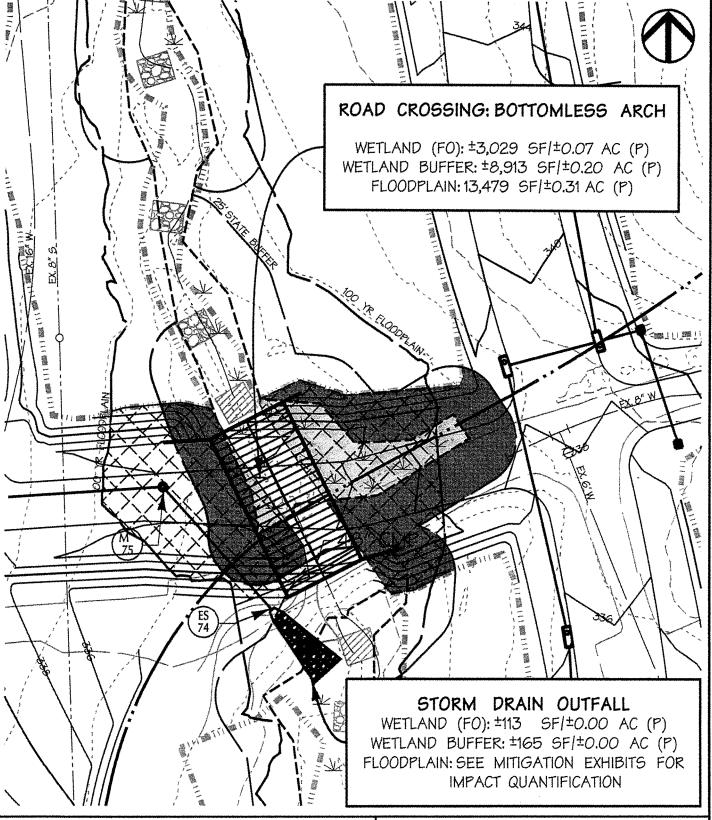

IMPACT EXHIBIT 'A'

STREAM CROSSING #1 AND STORM DRAIN

COLUMBIA CRESCENT

BROKENLAND PARKWAY HOWARD COUNTY COLUMBIA, MARYLAND


5 ELECTION DISTRICT QUI 10130/14 KMM COUNCILMANIC DISTRICT 4


Job No. 04038.A2 Scale: 1" = 50' Date: 07/01/14

Drawn By: GMO

DAFT MCCUNE WALKER INC

200 EAST PENNSYLVANIA AVENUE . TOWSON, MD 21286 F: 410 296 4705 WWW.DMW.COM P: 410 296 3333

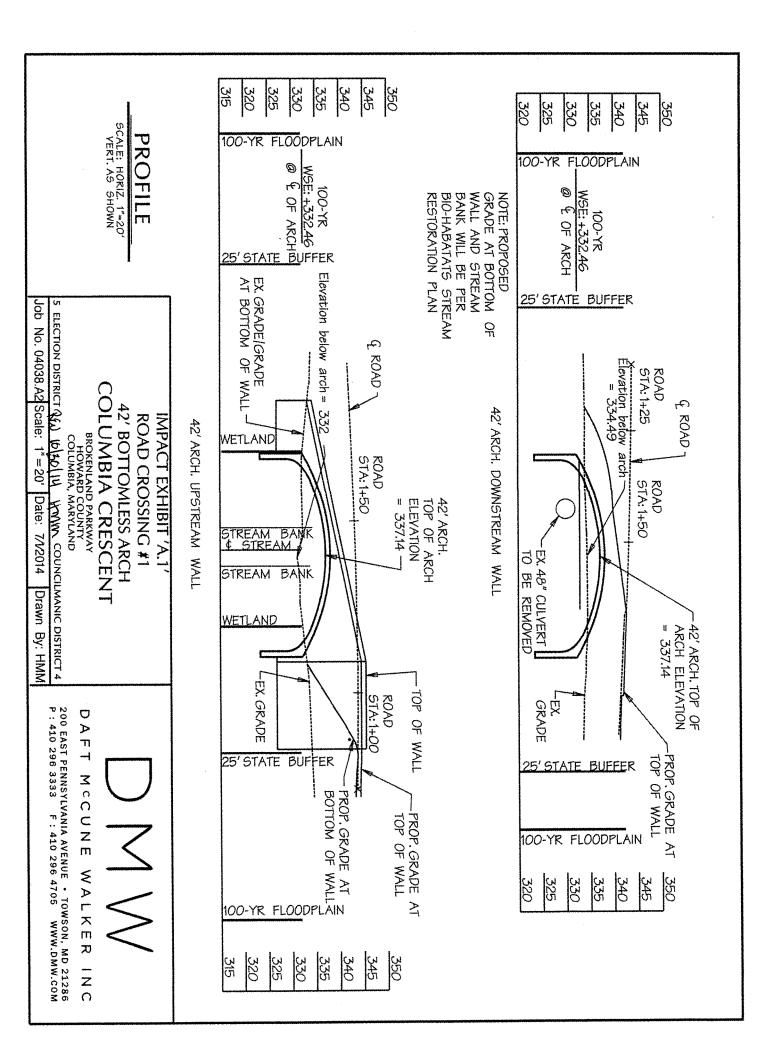

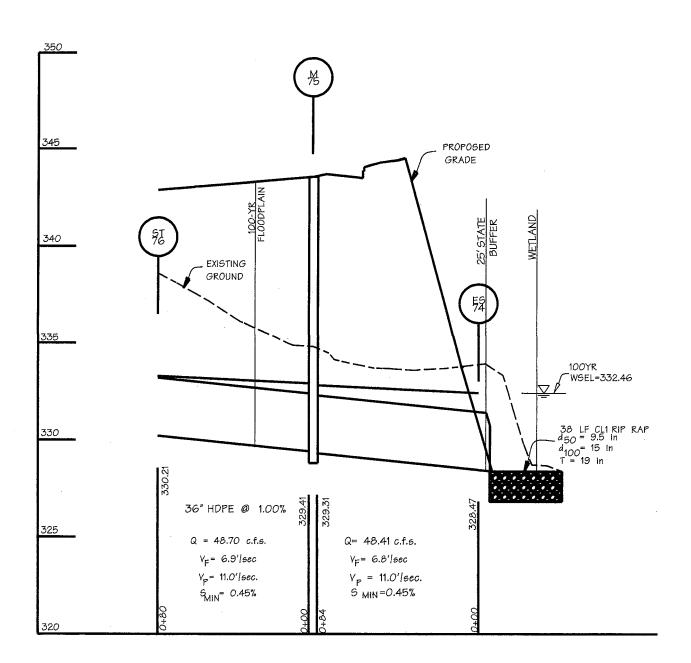

IMPACT EXHIBIT 'A.2' STORM DRAIN PROFILE

COLUMBIA CRESCENT

BROKENLAND PARKWAY HOWARD COUNTY COLUMBIA, MARYLAND


HMM COUNCILMANIC DISTRICT 4 5 ELECTION DISTRICT REW 10/30/14 Date: 7/1/2014 Job No. 04038.A2 Scale: 1" = 50'

Drawn By: HMM




DAFT MCCUNE WALKER INC

200 EAST PENNSYLVANIA AVENUE • TOWSON, MD 21286 P: 410 296 3333 F: 410 296 4705 WWW.DMW.COM

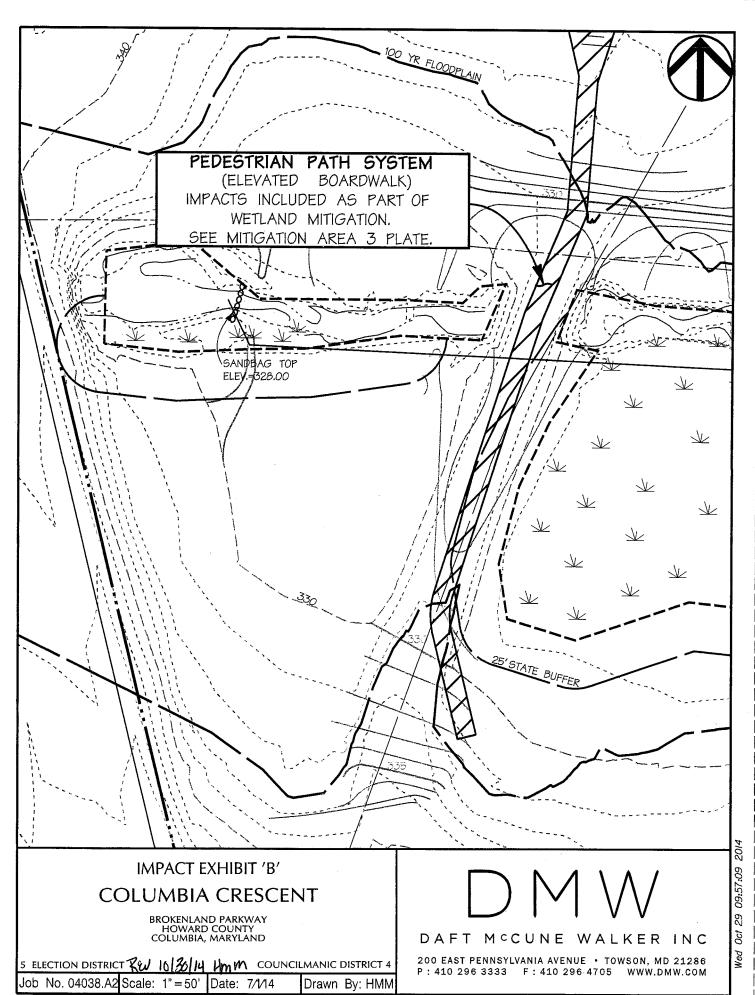

P:\04038.AI\ENGR\04038.EXHB

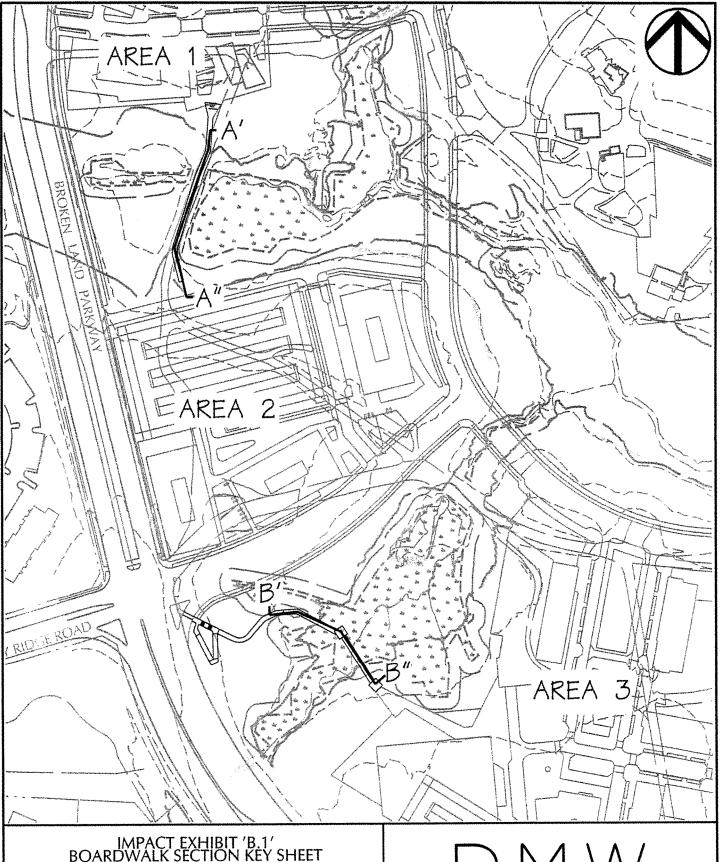

IMPACT EXHIBIT 'B.1' BOARDWALK SECTION KEY SHEET

COLUMBIA CRESCENT

BROKENLAND PARKWAY HOWARD COUNTY COLUMBIA, MARYLAND


5 ELECTION DISTRICT REW WISO 14 LYMM COUNCILMANIC DISTRICT 4


Job No. 04038,A2 Scale: 1" = 200' Date: 7/V2014 Drawn By: HMM

DAFT MCCUNE WALKER INC

200 EAST PENNSYLVANIA AVENUE • TOWSON, MD 21286 P: 410 296 3333 F: 410 296 4705 WWW.DMW.COM

07:55:04 29 Oct Wed

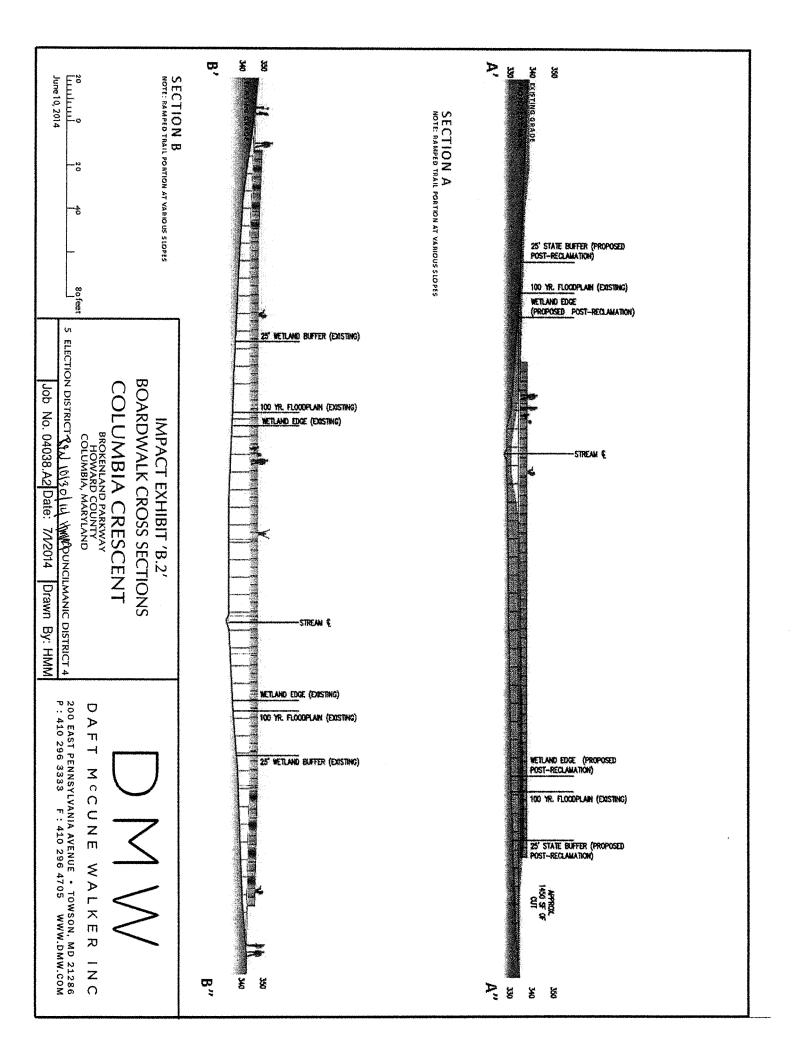

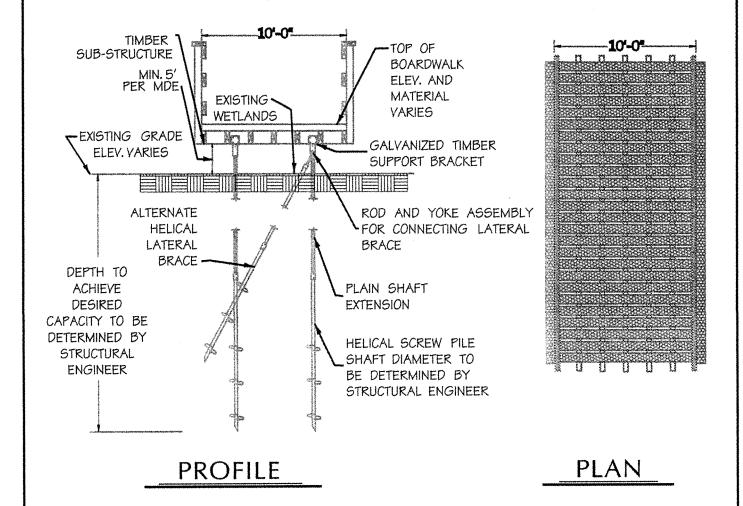

NOT FOR CONSTRUCTION

IMPACT EXHIBIT 'B.3' TYPICAL BOARDWALK PLAN AND PROFILE COLUMBIA CRESCENT

BROKENLAND PARKWAY HOWARD COUNTY COLUMBIA, MARYLAND


5 ELECTION DISTRICT FOU 10/20/14 HMM COUNCILMANIC DISTRICT 4


Job No. 04038.A2 SCALE: NTS | Date: 7/1/2014 | Drawn By: DRC





DAFT MCCUNE WALKER INC

200 EAST PENNSYLVANIA AVENUE • TOWSON, MD 21286 P: 410 296 3333 F: 410 296 4705 WWW.DMW.COM Wed Oct 29 07:55:44 2014

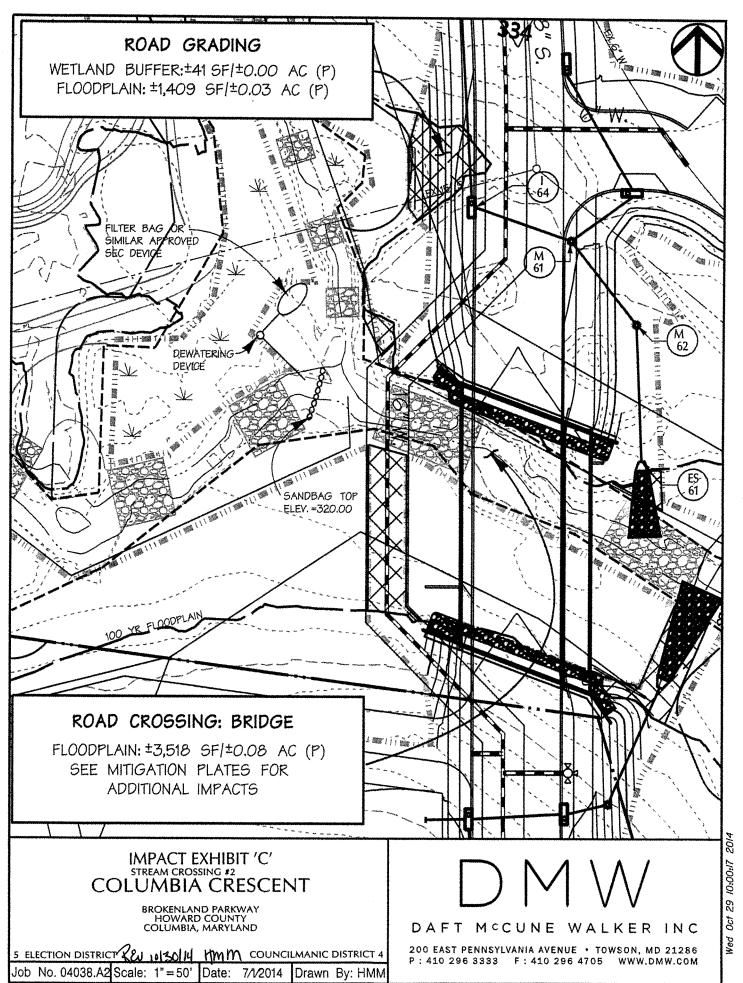

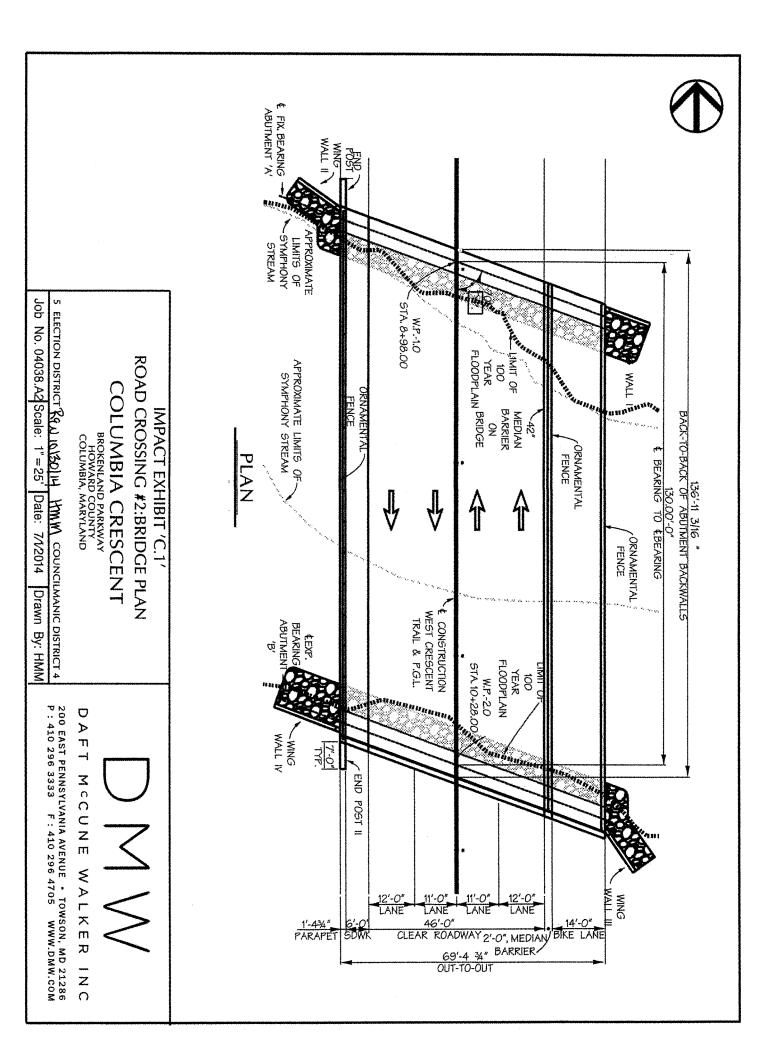

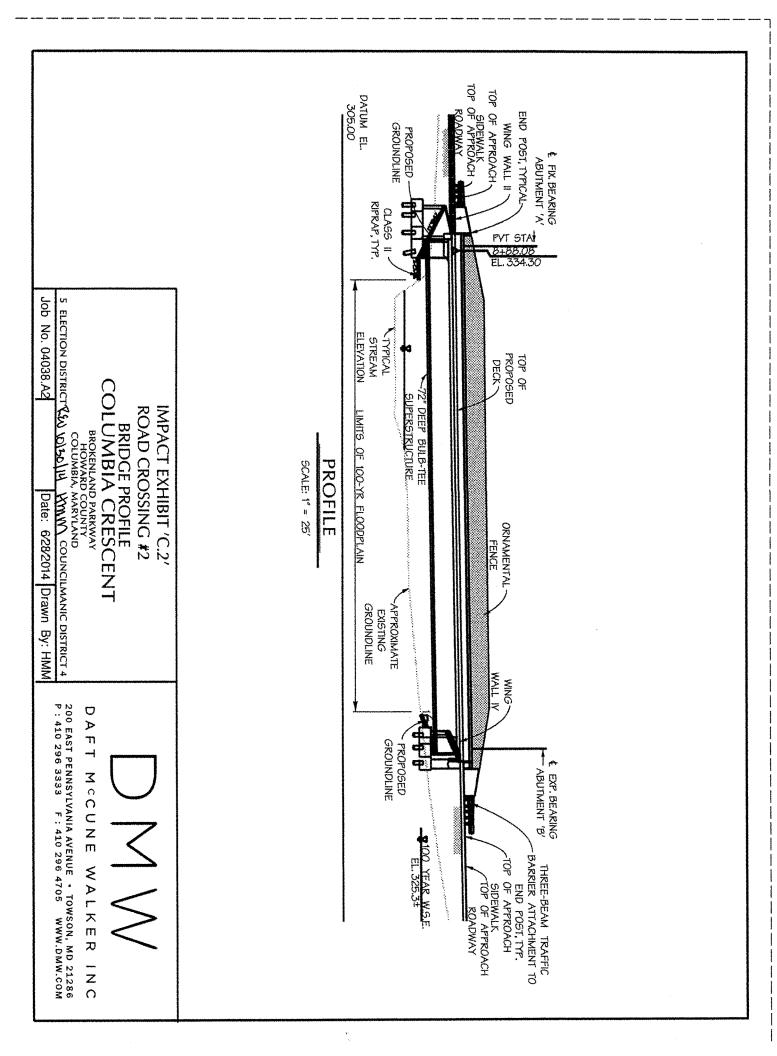

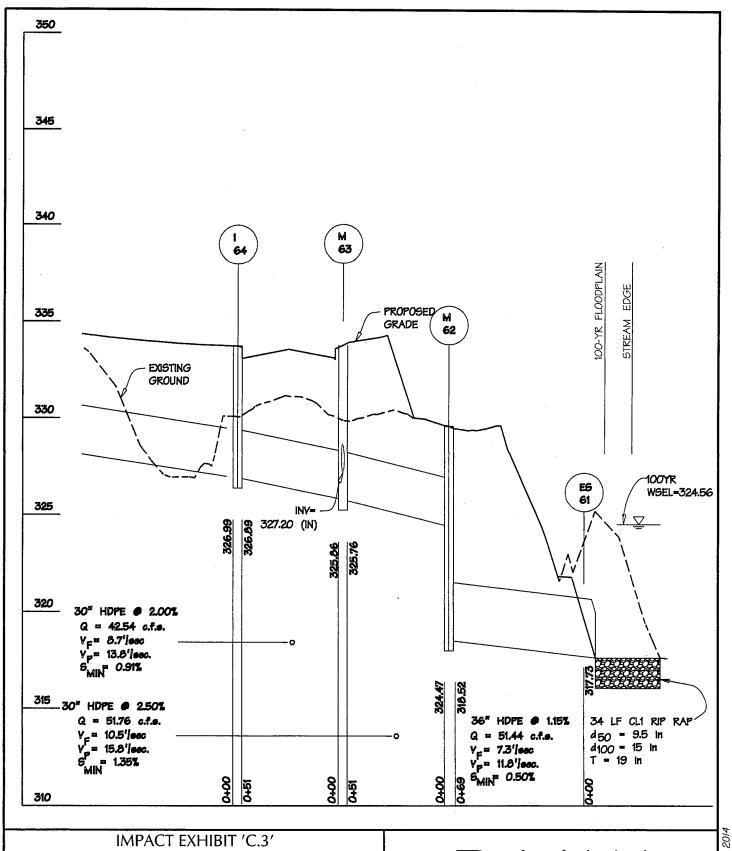

IMPACT EXHIBIT 'C.3' STORM DRAIN PROFILE

(CROSSING #2 NORTH)

COLUMBIA CRESCENT


BROKENLAND PARKWAY HOWARD COUNTY COLUMBIA, MARYLAND

HMM COUNCILMANIC DISTRICT 4 5 ELECTION DISTRICT REAL 10180 14 Job No. 04038.A2 Scale: 1" = 50' Date: 7/01/2014 Drawn By: HMM



DAFT MCCUNE WALKER INC

200 EAST PENNSYLVANIA AVENUE • TOWSON, MD 21286 P: 410 296 3333 F: 410 296 4705 WWW.DMW.COM Oct 31 11:04:20

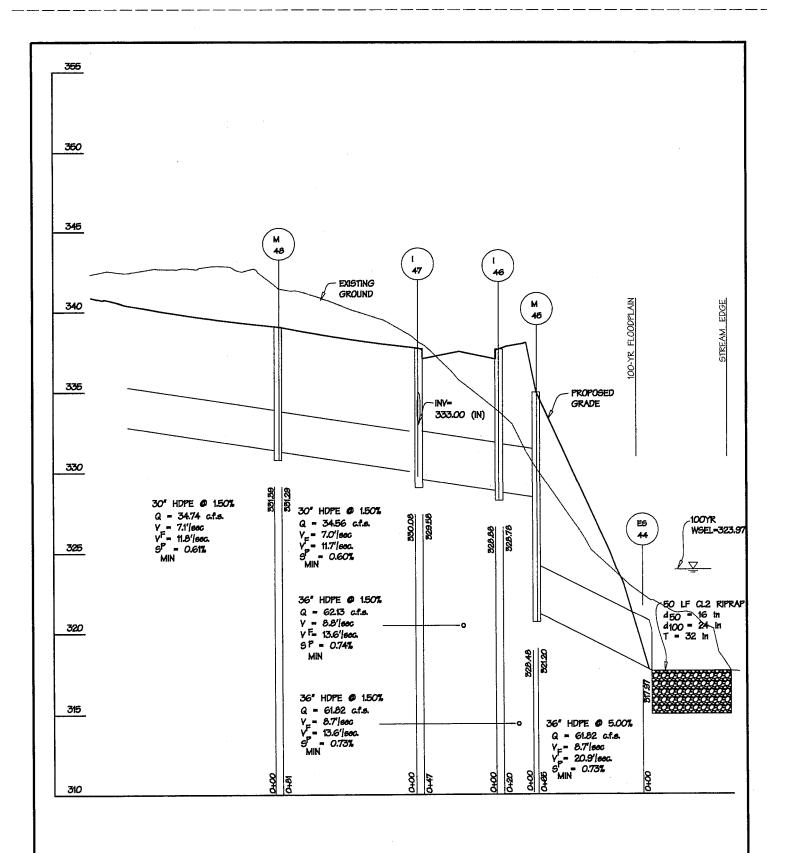

IMPACT EXHIBIT 'C.4' STORM DRAIN PROFILE (CROSSING #2 SOUTH)

COLUMBIA CRESCENT

BROKENLAND PARKWAY HOWARD COUNTY COLUMBIA, MARYLAND


5 ELECTION DISTRICT R. 10\30 14 MM MEOUNCILMANIC DISTRICT 4.

Job No. 04038.A2 Scale: 1"=60' Date: 7/01/2014 Drawn By: HMM



DAFT MCCUNE WALKER INC

200 EAST PENNSYLVANIA AVENUE • TOWSON, MD 21286 P: 410 296 3333 F: 410 296 4705 WWW.DMW.COM Fri Oct 31 11:19:48 2014

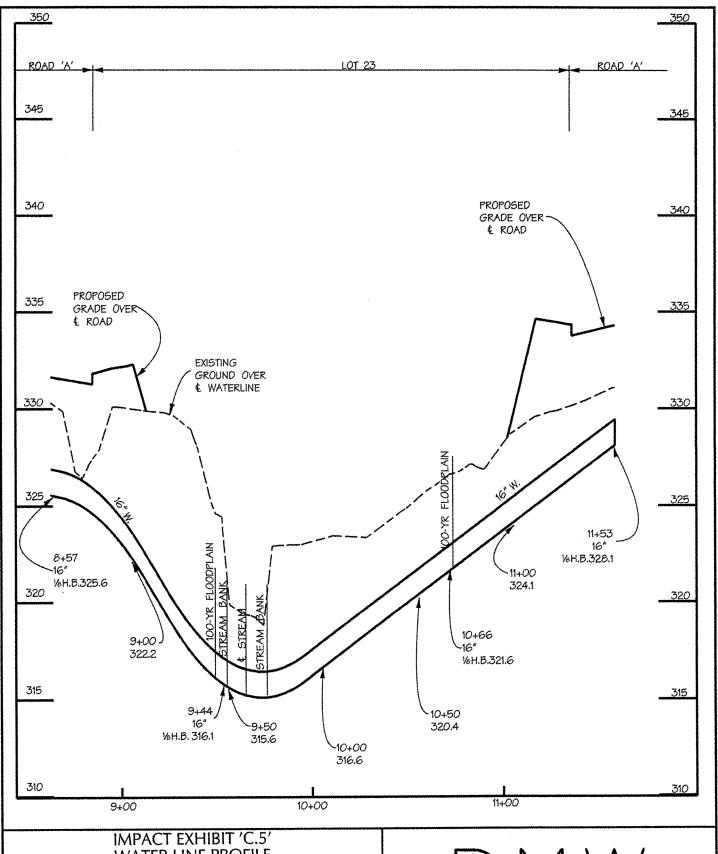

IMPACT EXHIBIT 'C.5'
WATER LINE PROFILE
COLUMBIA CRESCENT

BROKENLAND PARKWAY HOWARD COUNTY COLUMBIA, MARYLAND

5 ELECTION DISTRICT PEW 10/30/14 HMM COUNCILMANIC DISTRICT 4

Job No. 04038.A2 Scale: 1"=50' Date:

Date: 7/1/2014


Drawn By: HMM

DMW

DAFT MCCUNE WALKER INC

200 EAST PENNSYLVANIA AVENUE • TOWSON, MD 21286 P: 410 296 3333 F: 410 296 4705 WWW.DMW.COM

Wed Oct 29 07:58:45 2014

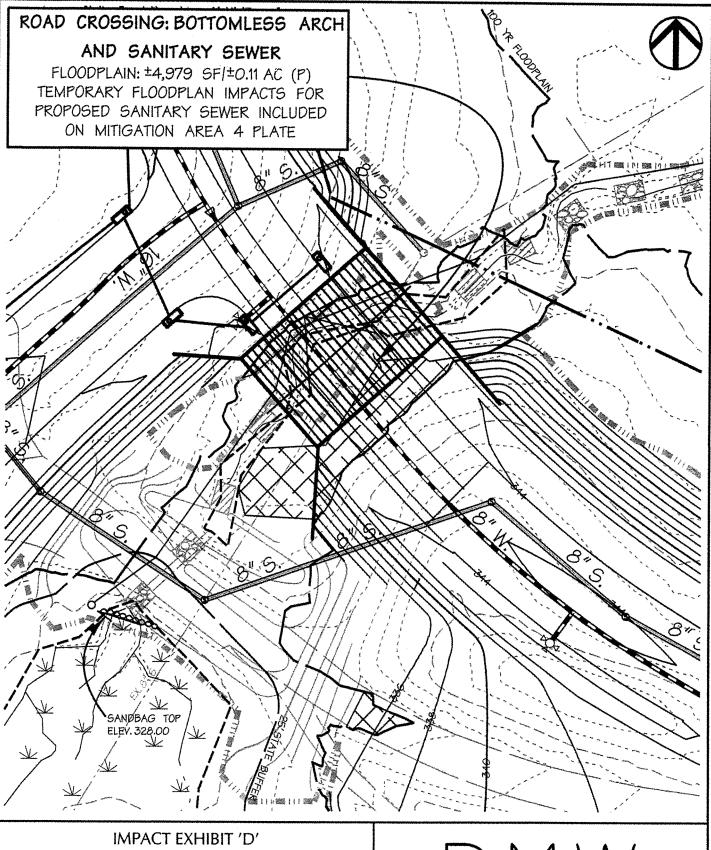

STREAM CROSSING #3

COLUMBIA CRESCENT

BROKENLAND PARKWAY HOWARD COUNTY COLUMBIA, MARYLAND

5 ELECTION DISTRICT REW 10130114 HMM COUNCILMANIC DISTRICT 4


Job No. 04038.A2 Scale: 1" = 50' Date: 07/1/14


Drawn By: GMO


DAFT MCCUNE WALKER INC

200 EAST PENNSYLVANIA AVENUE • TOWSON, MD 21286 P: 410 296 3333 F: 410 296 4705 WWW.DMW.COM


Oct Wed

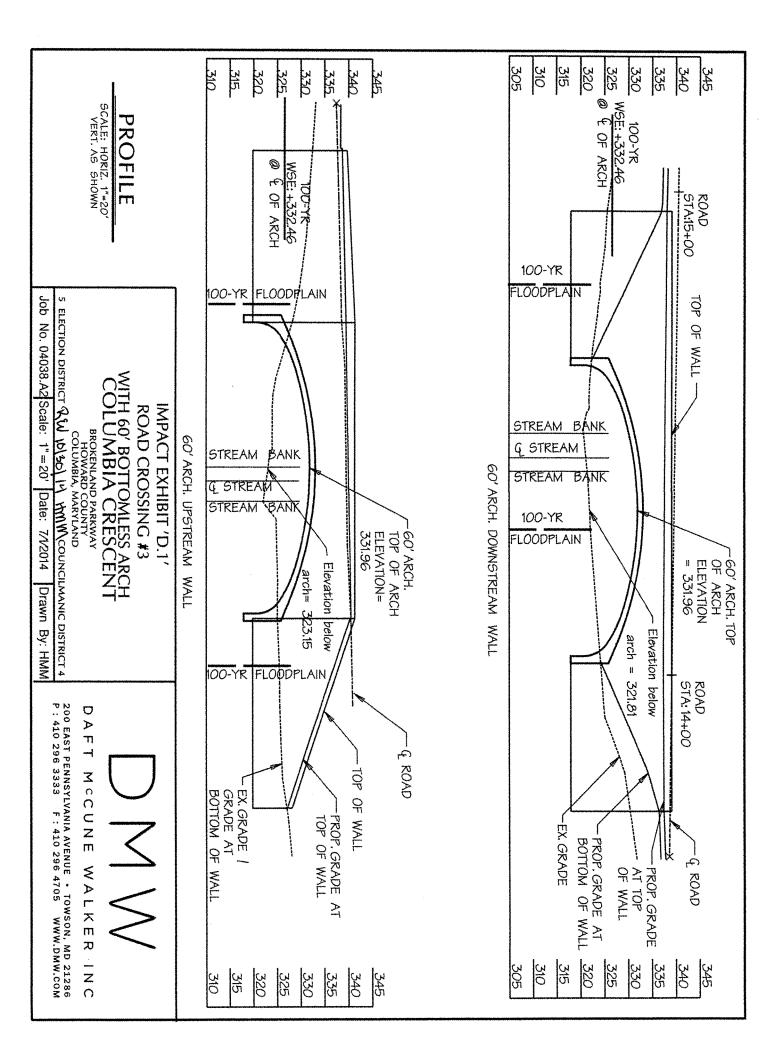

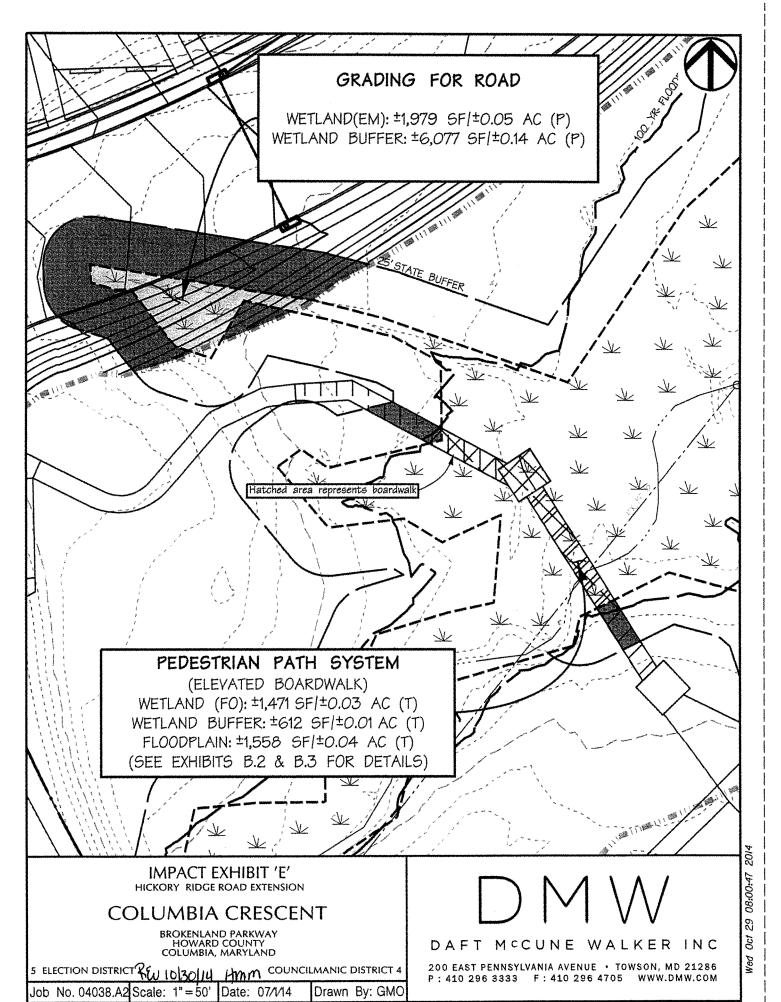

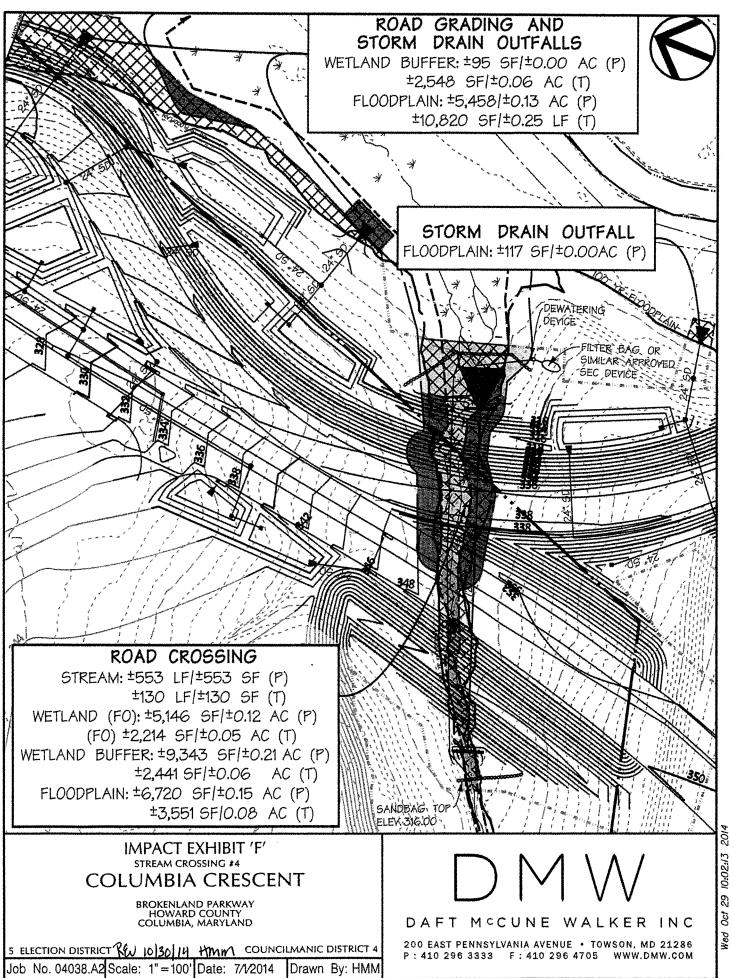

P:\04038.AI\ENGR\04038.EXHF

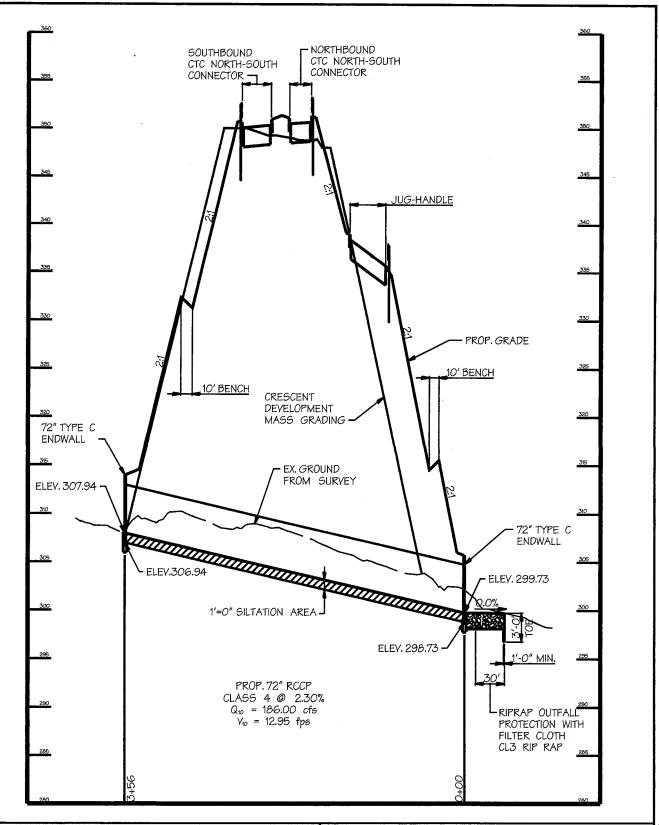

IMPACT EXHIBIT 'F.1'
CROSSING #4: 72" CULVERT
COLUMBIA CRESCENT

BROKENLAND PARKWAY HOWARD COUNTY COLUMBIA, MARYLAND

5 ELECTION DISTRICT 26N 16/30/14 MM M COUNCILMANIC DISTRICT 4

Job No. 04038.A2 Scale: 1"=100' Date: 7/01/2014 Drawn By: HMM




DAFT MCCUNE WALKER INC

200 EAST PENNSYLVANIA AVENUE • TOWSON, MD 21286 P: 410 296 3333 F: 410 296 4705 WWW.DMW.COM

P:\04038.AI\ENGR\04038.EXHFI

Fr1 Oct 31 10:49:11 2014

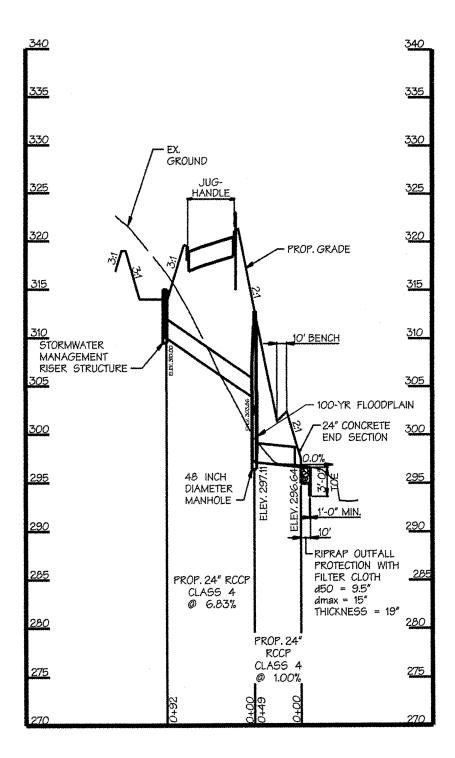

IMPACT EXHIBIT 'F.2' STORM DRAIN PROFILE (JUG-HANDLE NORTH)

COLUMBIA CRESCENT


BROKENLAND PARKWAY HOWARD COUNTY COLUMBIA, MARYLAND

5 ELECTION DISTRICT REW 10/30/14 Hmmcouncilmanic DISTRICT 4

Job No. 04038.A2 Scale: 1"=100" Date: 7/01/2014 Drawn By: HMM



DAFT MCCUNE WALKER INC

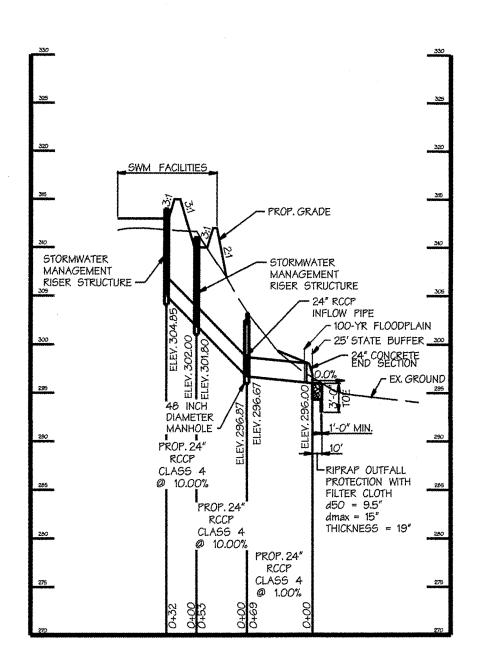

IMPACT EXHIBIT 'F.3' STORM DRAIN PROFILE (JUG-HANDLE MIDDLE)


COLUMBIA CRESCENT

BROKENLAND PARKWAY
HOWARD COUNTY
COLUMBIA, MARYLAND
1 103114 HMMCOUNCILMANIC DISTRICT 4 5 ELECTION DISTRICT PLAN

Job No. 04038.A2 Scale: 1" = 100' Date: 7/1/2014 Drawn By: HMM



DAFT MCCUNE WALKER INC

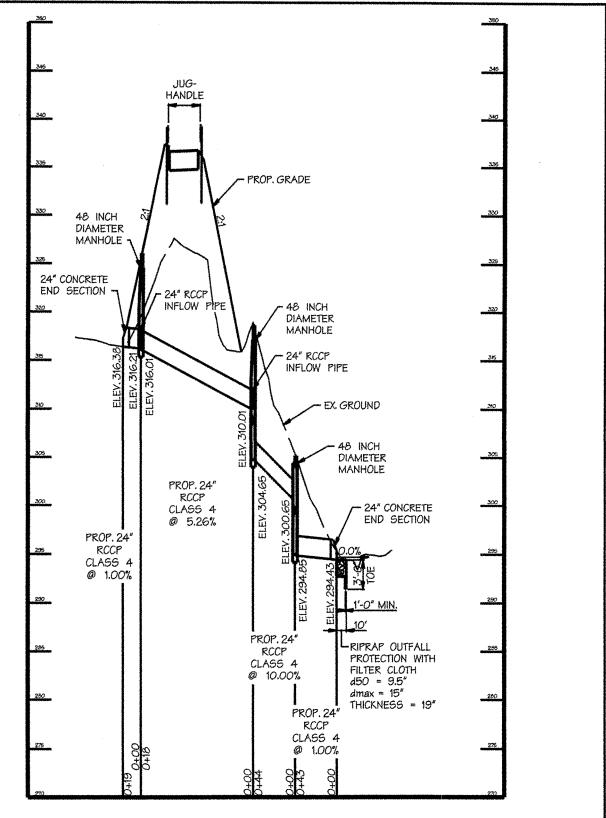

IMPACT EXHIBIT 'F.4'
STORM DRAIN OUTFALL
(JUG-HANDLE SOUTH)

COLUMBIA CRESCENT

BROKENLAND PARKWAY HOWARD COUNTY COLUMBIA, MARYLAND

5 ELECTION DISTRICT (9.) 16/30/14 HMM COUNCILMANIC DISTRICT 4


Job No. 04038.A2 Scale: 1"=100' Date: 7/01/2014 Drawn By: HMM

DMW

DAFT MCCUNE WALKER INC


200 EAST PENNSYLVANIA AVENUE • TOWSON, MD 21286 P: 410 296 3333 F: 410 296 4705 WWW.DMW.COM

Wed Oct 29 09:02:00 2014

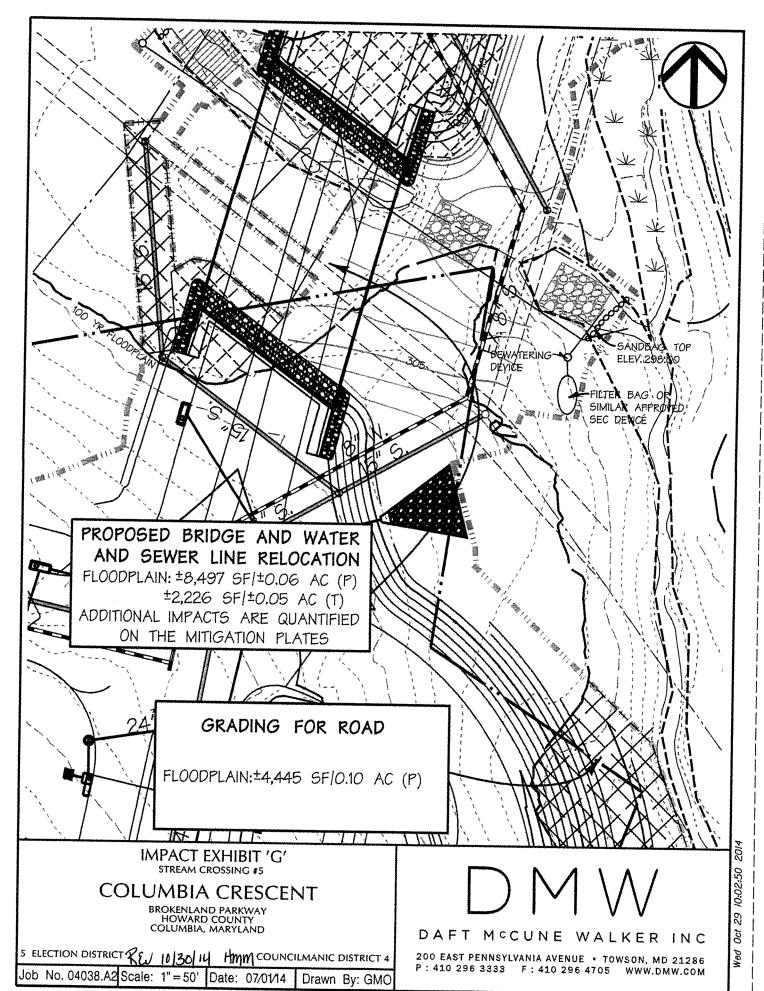


P:\04038.AI\ENGR\04038.EXHG



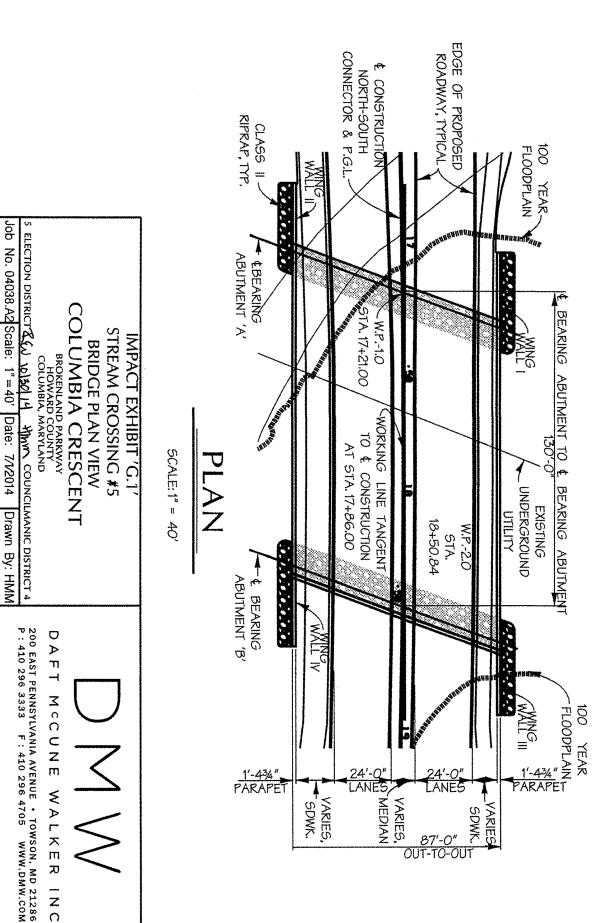

DAFT MCCUNE WALKER INC

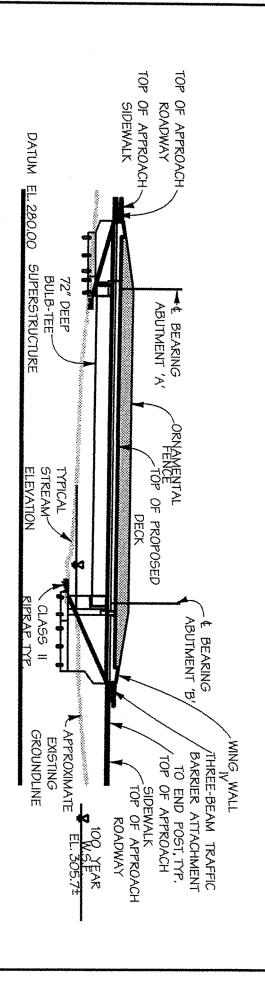

PROFILE


SCALE: 1" = 40"


IMPACT EXHIBIT 'G.2'
STREAM CROSSING #5
BRIDGE PROFILE
COLUMBIA CRESCENT

BROKENLAND PARKWAY
HOWARD COUNTY
COLUMBIA, MARYLAND
5 ELECTION DISTRICT (15) 10/30/14 Y(WWOOUNCILMANIC DISTRICT 4
Job No. 04038.A2 Scale: 1"=40' Date: 7/1/2014 Drawn By: HMM

 \bigcup \bigvee

DAFT MCCUNE WALKER INC

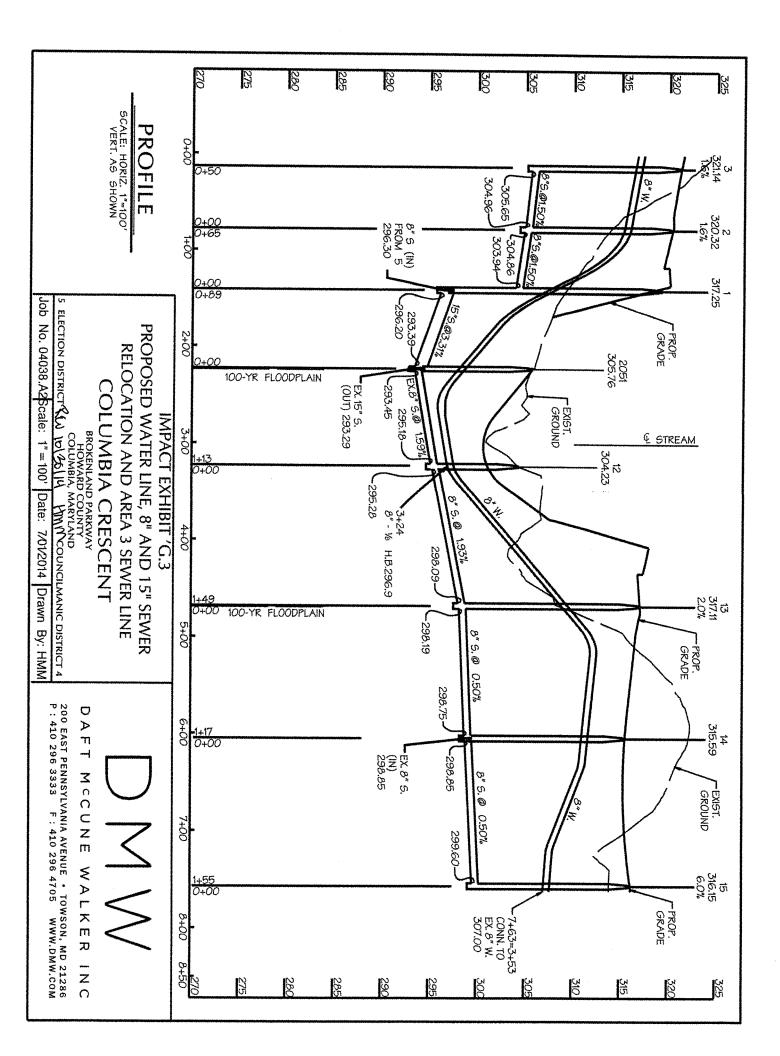

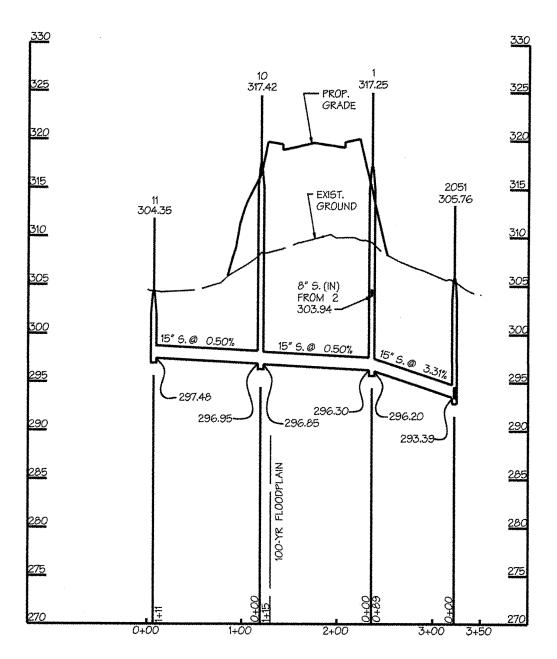

PROFILE

SCALE: HORIZ. 1"=100" VERT. AS SHOWN

IMPACT EXHIBIT 'G.4' SEWER RELOCATION

COLUMBIA CRESCENT

BROKENLAND PARKWAY HOWARD COUNTY COLUMBIA, MARYLAND

5 ELECTION DISTRICT REU 16/26/14 HMW COUNCILMANIC DISTRICT 4


Job No. 04038.A2 Scale: 1"=100' Date: 7/01/2014 Drawn By: HMM




DAFT MCCUNE WALKER INC

200 EAST PENNSYLVANIA AVENUE • TOWSON, MD 21286 P: 410 296 3333 F: 410 296 4705 WWW.DMW.COM

Wed Oct 29 08:15:36 20

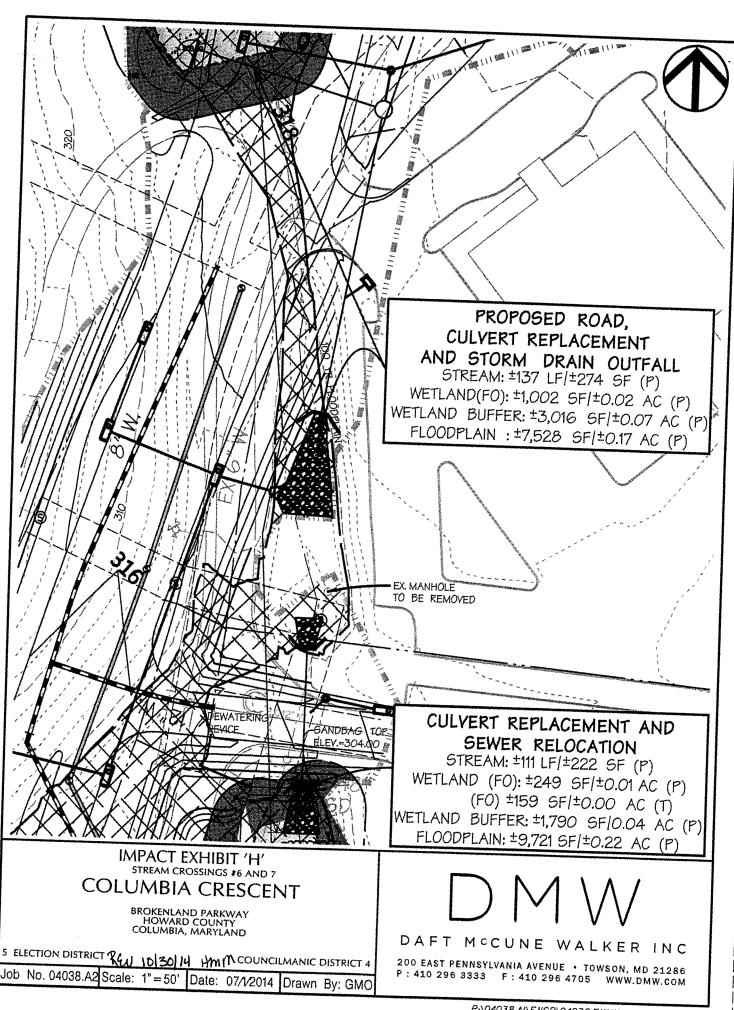

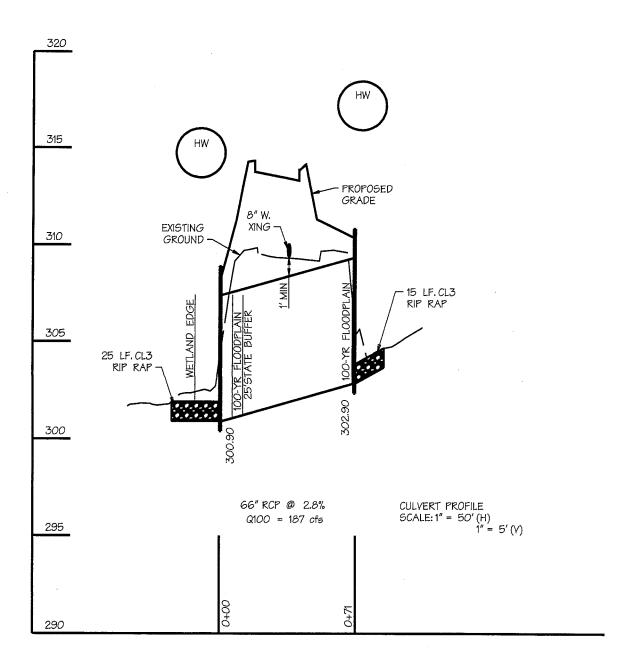

IMPACT EXHIBIT 'H.1'
CROSSING #6-CULVERT REPLACEMENT
COLUMBIA CRESCENT


BROKENLAND PARKWAY HOWARD COUNTY COLUMBIA, MARYLAND


5 ELECTION DISTRICT REW 10(30/14 HMW) COUNCILMANIC DISTRICT 4

Job No. 04038.A2 Scale: 1"=50' Date: 7/01/2014 Drawn By: HMM



DAFT MCCUNE WALKER INC

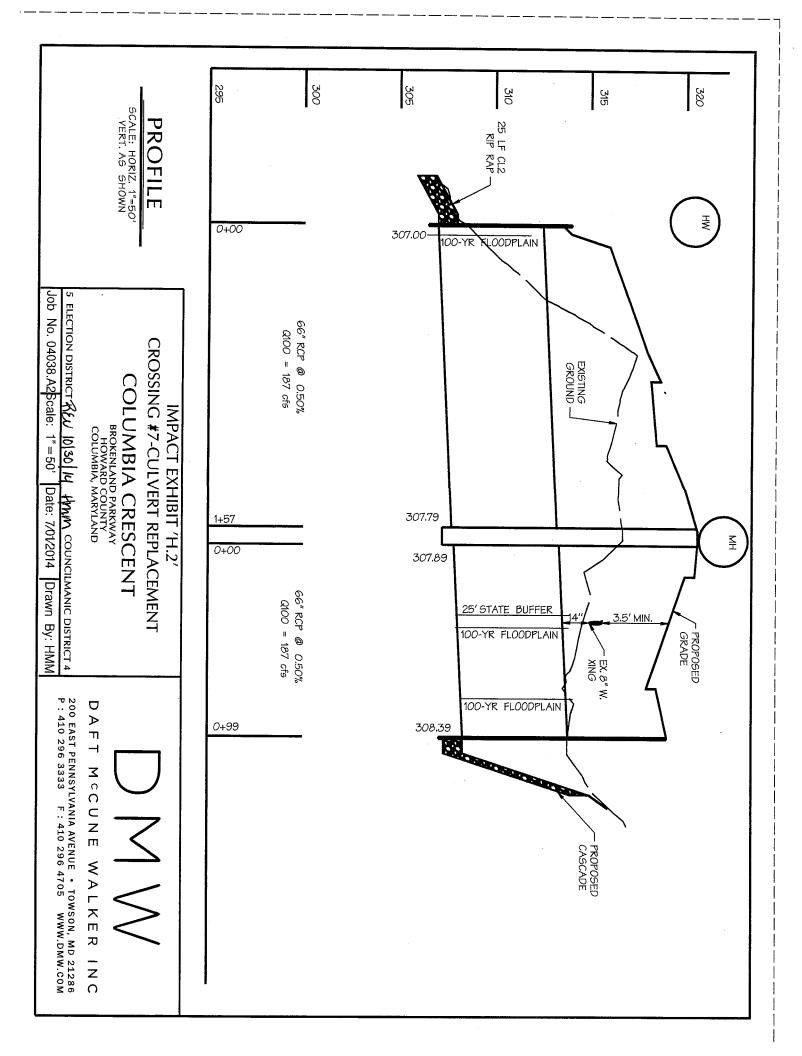

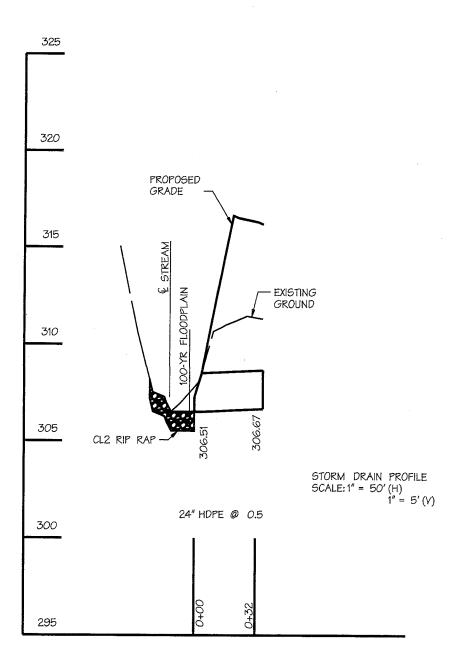

IMPACT EXHIBIT 'H.3' STORM DRAIN PROFILE (BELOW CROSSING #7)

COLUMBIA CRESCENT


BROKENLAND PARKWAY HOWARD COUNTY COLUMBIA, MARYLAND

5 ELECTION DISTRICT (10120) HYMM COUNCILMANIC DISTRICT 4

Job No. 04038.A2 Scale: 1"=50' Date: 7/01/2014 Drawn By: HMM



DAFT MCCUNE WALKER INC

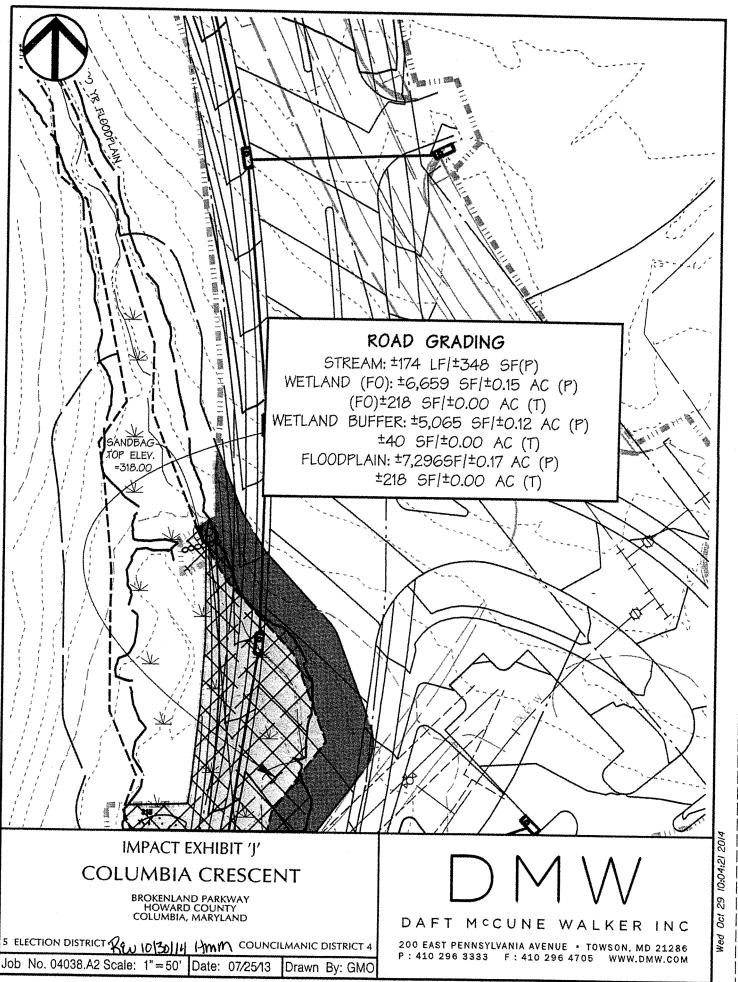

P:\04038.AI\ENGR\04038.EXHJ



2014 Oct 29 08:30:22 Wed

BROKENLAND PARKWAY HOWARD COUNTY COLUMBIA, MARYLAND


COLUMBIA CRESCENT

5 ELECTION DISTRICT LEW 16/30/14 HMM COUNCILMANIC DISTRICT 4

Job No. 04038.A2 Scale: 1"=500" Date: 7/1/14

Drawn By: HMM

DAFT MCCUNE WALKER INC

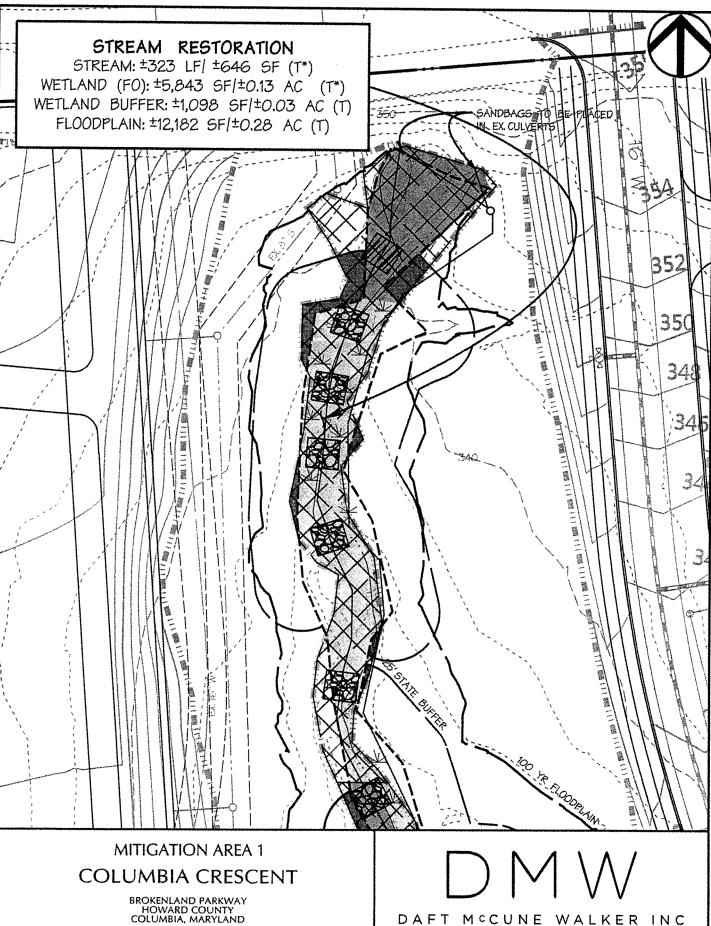

Drawn By: HMM

5 ELECTION DISTRICT REAL BOST HIMM COUNCILMANIC DISTRICT 4


Job No. 04038.A2 Scale: 1"=50' Date: 7/1/14

2014 08:21:39 23 Oct Wed

DAFT MCCUNE WALKER INC

200 EAST PENNSYLVANIA AVENUE . TOWSON, MD 21286

P: 410 296 3333 F: 410 296 4705 WWW.DMW.COM

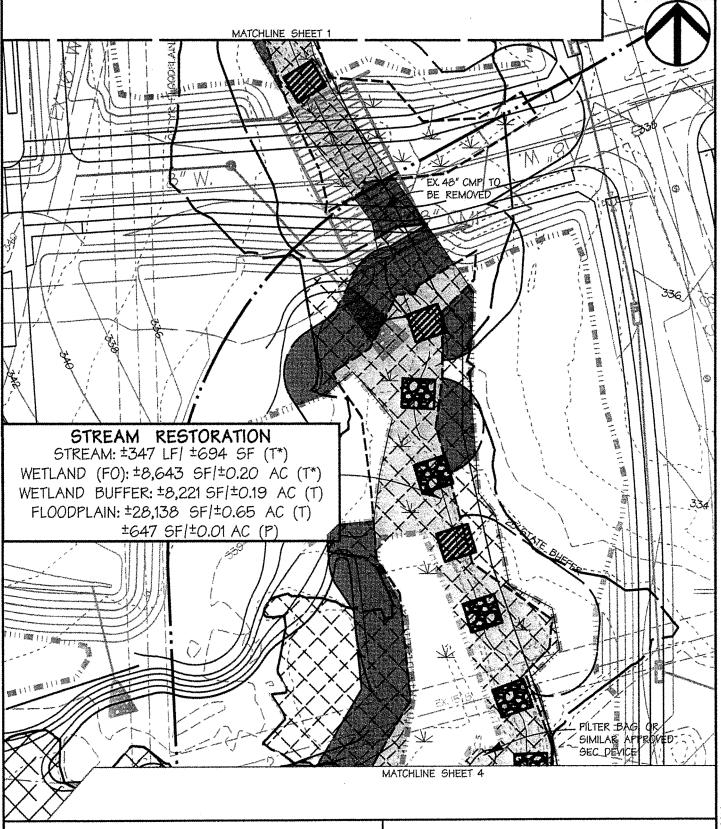

MITIGATION AREA 2 COLUMBIA CRESCENT

BROKENLAND PARKWAY HOWARD COUNTY COLUMBIA, MARYLAND


5 ELECTION DISTRICT REJ 10/30/14 HMM COUNCILMANIC DISTRICT 4

Job No. 04038.A2 Scale: 1"=50' Date: 7/1/14 Drawn By: HMM


MM P

DMW

DAFT MCCUNE WALKER INC

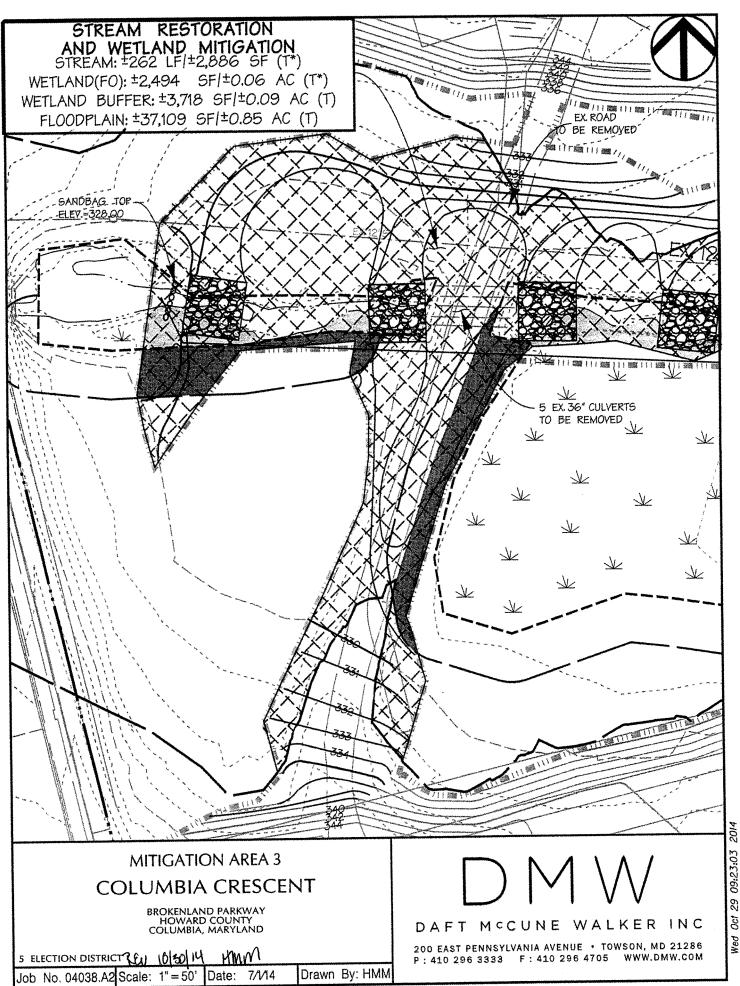


Wed

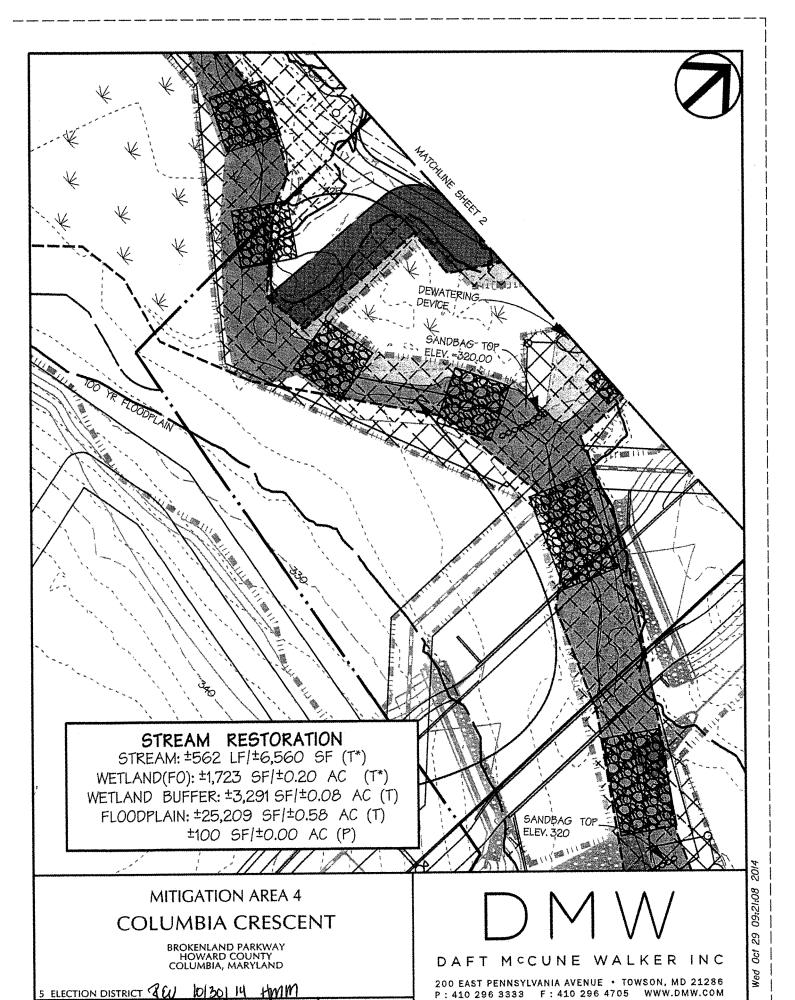


Drawn By: HMM

Job No. 04038.A2 Scale: 1"=50' Date: 7/1/2014

P:\04038.AI\ENGR\04038.EXHMIt4v2

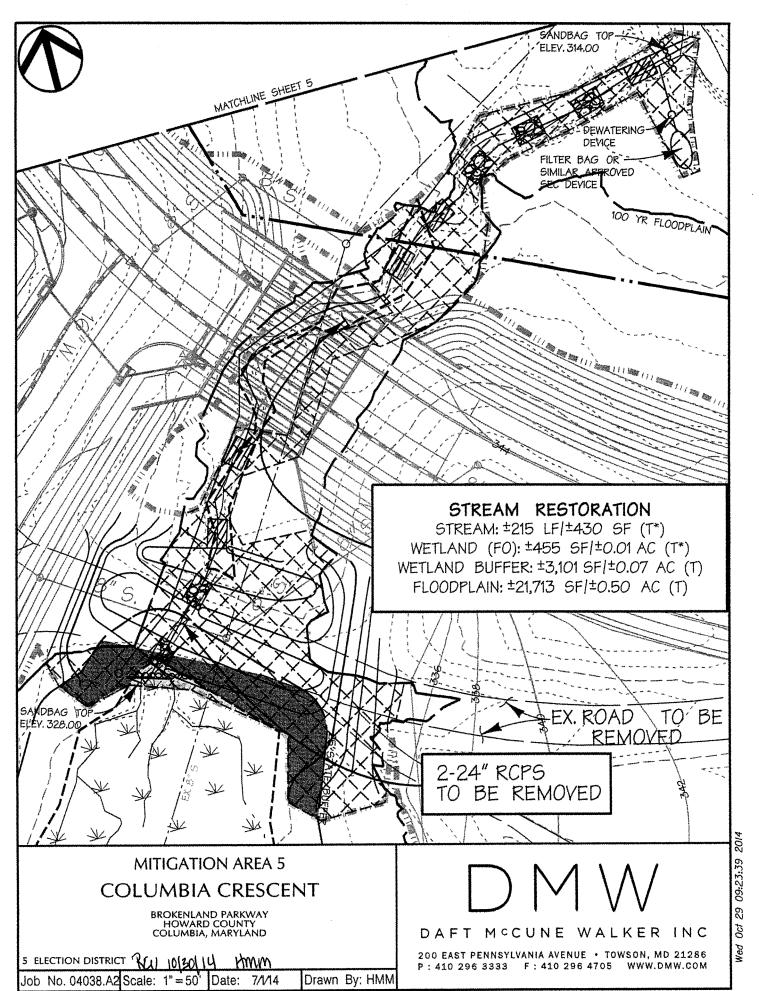

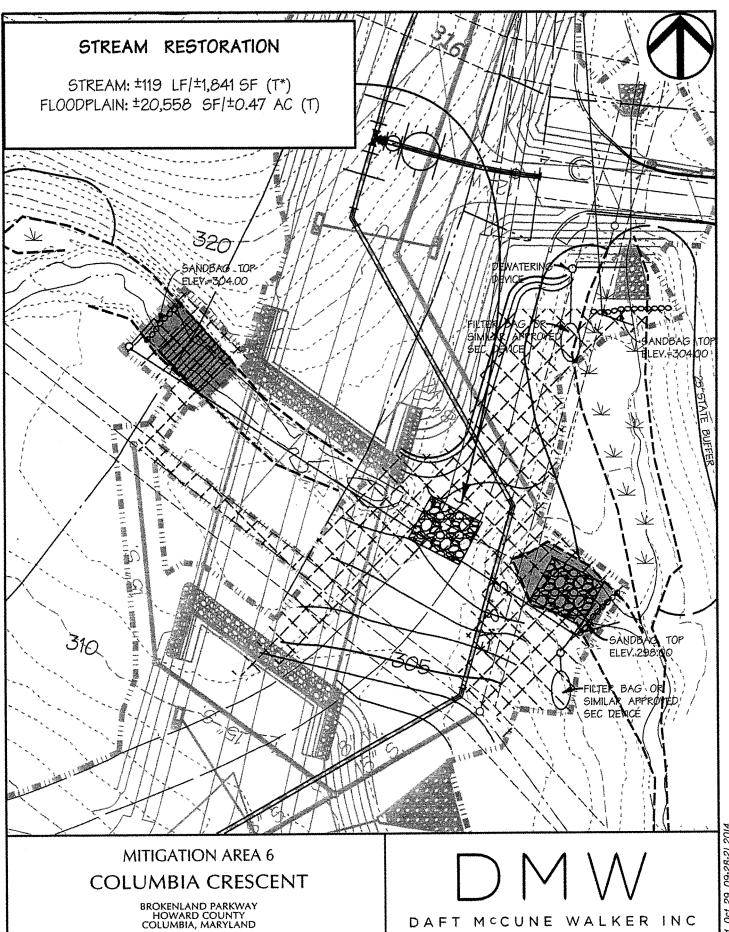


09:28:21 2014 29 Oct

200 EAST PENNSYLVANIA AVENUE . TOWSON, MD 21286 P: 410 296 3333 F: 410 296 4705 WWW.DMW.COM

7 ELECTION DISTRICT REW 10/30/14 TMM COUNCILMANIC DISTRICT 4

Job No. 04038.A2 Scale: 1"=50' Date: 7/1/2014 Drawn By: HMM

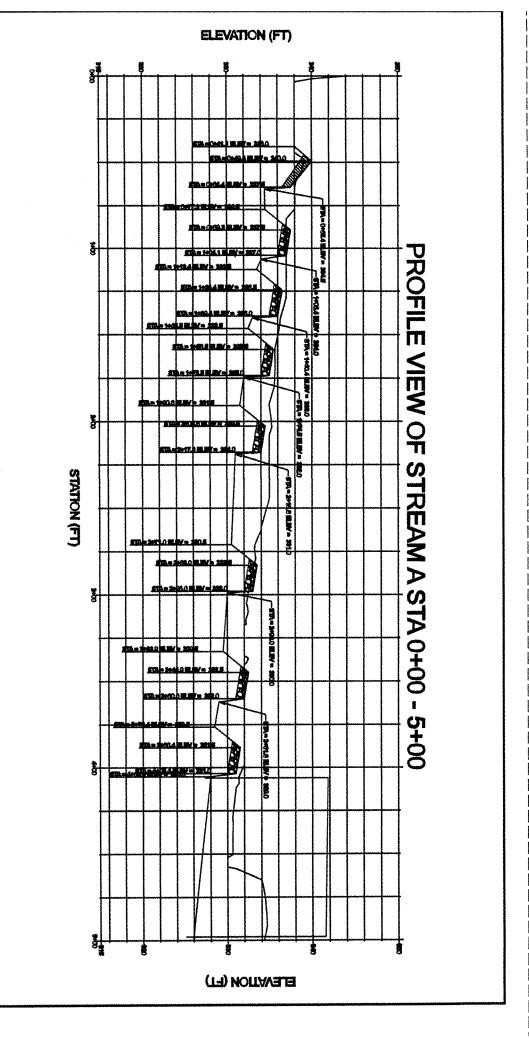

COLUMBIA CRESCENT BROKENLAND PARKWAY HOWARD COUNTY COLUMBIA, MARYLAND

DAFT MCCUNE WALKE


IJ

_ Z O

)
✓


ELECTION DISTRICT AW. 19(30)14 HMMCOUNCILMANIC DISTRICT 4

No. 04038.A2 Date: 7/1/2014 Drawn By: HMM 200 EAST PENNSYLVANIA AVENUE • TOWSON, MD 21286 P: 410 296 3333 F: 410 296 4705 WWW.DMW.COM

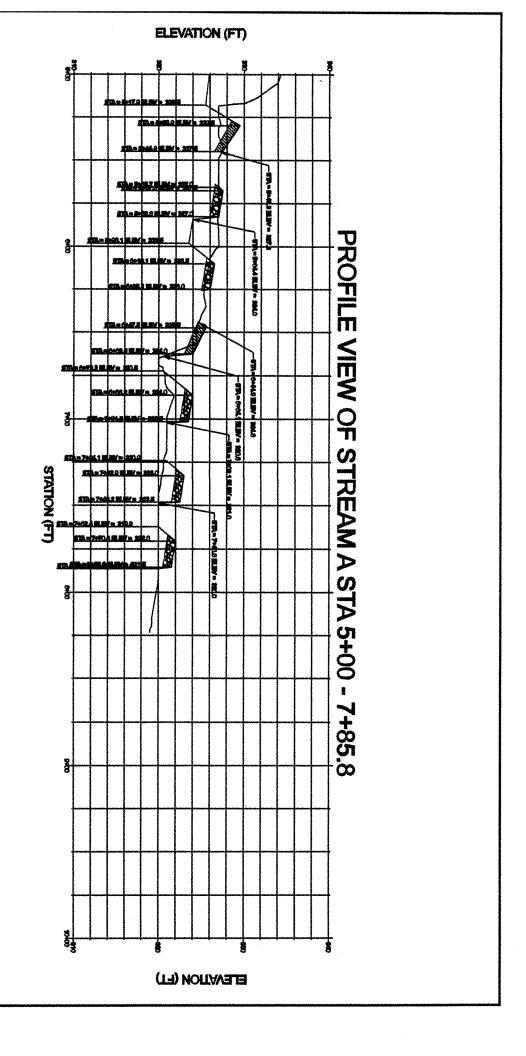


COLUMBIA CRESCENT
BROKENLAND PARKWAY
HOWARD COUNTY
COLUMBIA, MARYLAND

5 ELECTION DISTRICT PLAN 10/20/11 YMM COUNCILMANIC DISTRICT 4 Job No. 04038.A2 Date: 7/1/2014 Drawn By: HMM

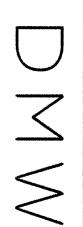

AFT MCCUNE WALKER _ Z O

O

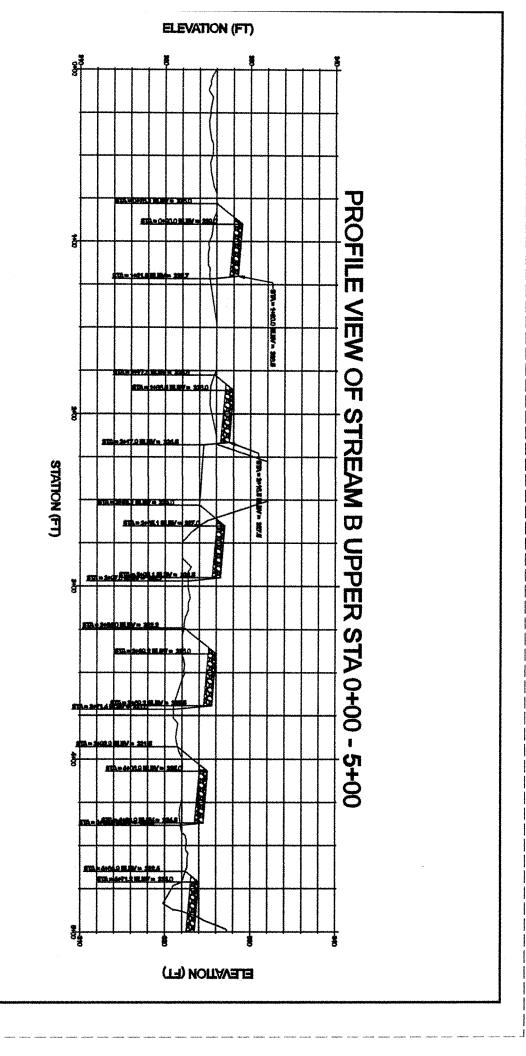


COLUMBIA CRESCENT BROKENLAND PARKWAY HOWARD COUNTY COLUMBIA, MARYLAND


ELECTION DISTRICT OF JUNE ANNI COUNCILMANIC DISTRICT 4 Job No. 04038,A2 Date: 7/1/2014 Drawn By: HMM

U M M

AFT MCCUNE WALKER _ Z O


O

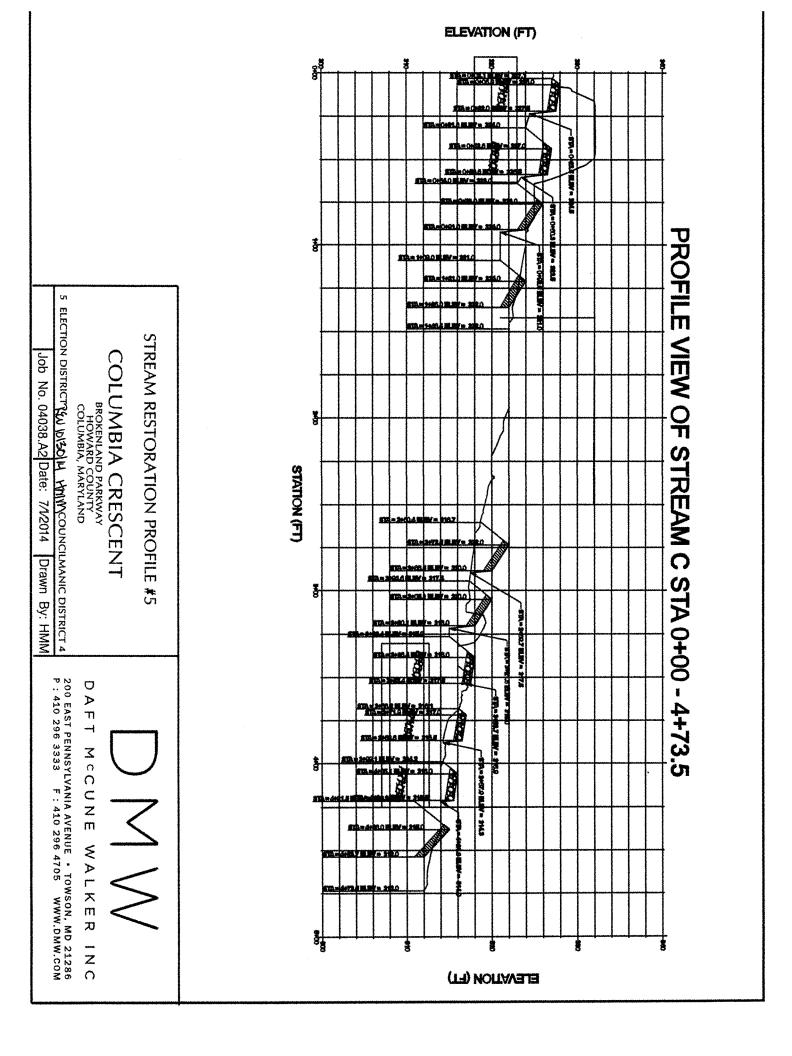

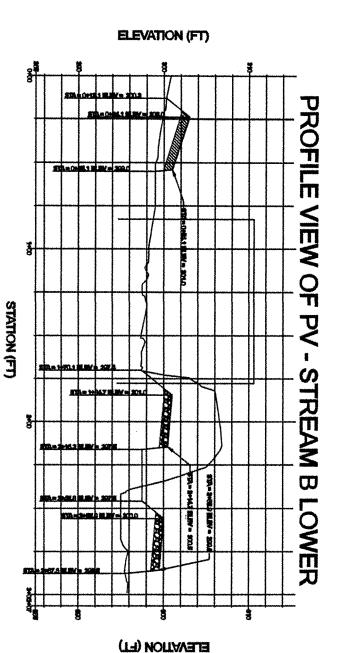

COLUMBIA CRESCENT
BROKENLAND PARKWAY
HOWARD COUNTY
COLUMBIA, MARYLAND

ELECTION DISTRICT (4) 10/30/14 HMM/COUNCILMANIC DISTRICT 4 Job No. 04038.A2 Date: 7/1/2014 Drawn By: HMM

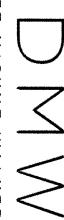

200 EAST PENNSYLVANIA AVENUE • TOWSON, MD 21286 P: 410 296 3333 F: 410 296 4705 WWW.DMW.COM U AFT MCCUNE WALKER INC